
COPY



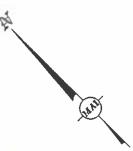

KNOWLTON FARMS SOLAR DEVELOPMENT 44 ESTABROOK AVENUE [PHASE THREE]

ASSESSOR'S MAP 49 - LOT 6 -APPLICATION FOR SPECIAL PERMIT--APPLICATION FOR SITE PLAN APPROVAL-

PLANS AND DESIGN HAVE BEEN DEVELOPED IN ACCORDANCE WITH THE PERFORMANCE STANDARDS SET FORTH IN SECTION 4.1 OF THE GRAFTON ZONING BYLAW & ARTICLE 36: STORMWATER MANAGEMENT BYLAW

LOCATED IN



GRAFTON, MASSACHUSETTS

DATE: JUNE 12, 2018 REVISED: AUGUST 3, 2018

RECORD OWNERS:

BLUEWAVE CAPITAL, LLC 137 NEWBURY STREET, FOURTH FLOOR BOSTON, MASSACHUSETTS 02116

APPLICANT:

B L U E W-A-V E

TEL: (817) 209-3122 FAX: (817) 395-2730 WWW.BLUEWAYE-CAPITAL.COM

LAND SURVEYOR/SITE CIVIL ENGINEER:

ASSOCIATES ES CENTER SUITE 5950 69 MILK STREET, SUITE 307 ASSACHUSETTS 01919 WESTBORDUCH, MASSACHUSETT ENVIRONMENTAL CONSULTANT:

KNOWLTON FARMS NOMINEE TRUST

PATRICIA K. KNOWLTON, TRS.

43 ESTABROOK AVENUE GRAFTON, MASSACHUSETTS 01519



LEC ENVIRONMENTAL CONSULTANTS, INC. 100 GROVE STREET, SUITE 302 WORCESTER, MA 01605 TEL: (508) 753-3077 FAX: (508) 753-3177 WWW.LECENVIRONMENTAL.COM

RECEIVED

AUG 7 2018

PHANNING BOARD

GRAFTON, MA

APPROVED BY:

GRAFTON PLANNING BOARD

LOCUS CONTEXT MAP:

GRAPHIC SCALE

SCALE: 1"=500"

PROJECT SUMMARY: THE PROJECT PROPOSES THE INSTALLATION OF 402
SOLAR PANEL TABLES CONTAINING A TOTAL OF 840
MODULES. THE SOLAR PANELS WILL BE INSTALLED AS
AN ELEVATED CANOPY THAT WILL ALLOW
ACRICULTURAL ACTIVITIES NAMELY, A COMBINATION OF
LIGHT LIVESTOCK AND FOOD CROPS TO CONTINUE UNIMPEDED UNDER THE ARRAY (I.E. "DUAL-USE").
THE SOLAR ENERGY FACILITY WILL PRODUCE APPROXIMATELY 3.11 MEGAWATTS DC (MWDC) OF POWER, AND 2.8 MEGAWATTS AC (NWAC) OF POWER.

DRAWING INDEX:

SHEET 1 COVER SHEET & LOCUS CONTEXT MAP

SHEET 2 RECORD CONDITIONS PLAN

PERMIT SITE PLAN OF LAND (DUAL-USE) SHEET 3

PERMIT SITE PLAN OF LAND (CONVENTIONAL) SHEET 4

SHEET 5 GRADING AND DRAINAGE PLAN

GRADING AND DRAINAGE PLAN SHEET 6

GRADING AND DRAINAGE PLAN SHEET 7

SEDIMENT AND EROSION CONTROL PLAN SHEET 8

SHEET 9 SEDIMENT AND EROSION CONTROL PLAN

SEDIMENT AND EROSION CONTROL PLAN SHEET 10

WETLAND CROSSING AND REPLICATION DETAILS SHEET 11

SEDIMENTATION BASIN GRADING DETAILS SHEET 12

SEDIMENT AND EROSION CONTROL DETAILS SHEET 13

SHEET 14

NOT FOR CONSTRUCTION

EXHIBIT 17


"THIS PLAN IS SUBJECT TO A SPECIAL PERMIT DATED ...

"THIS PLAN IS SUBJECT TO SITE PLAN APPROVAL DATED _____

"THIS PLAN IS SUBJECT TO A CERTIFICATE OF OF GOOD STANDING DATED JUNE 5, 2018"

SITE DETAILS FOR PERMITTING ONLY.

DWG. No. 6108-CVA (MAGE: USGS Color Ortho Imagery (2008/2009).

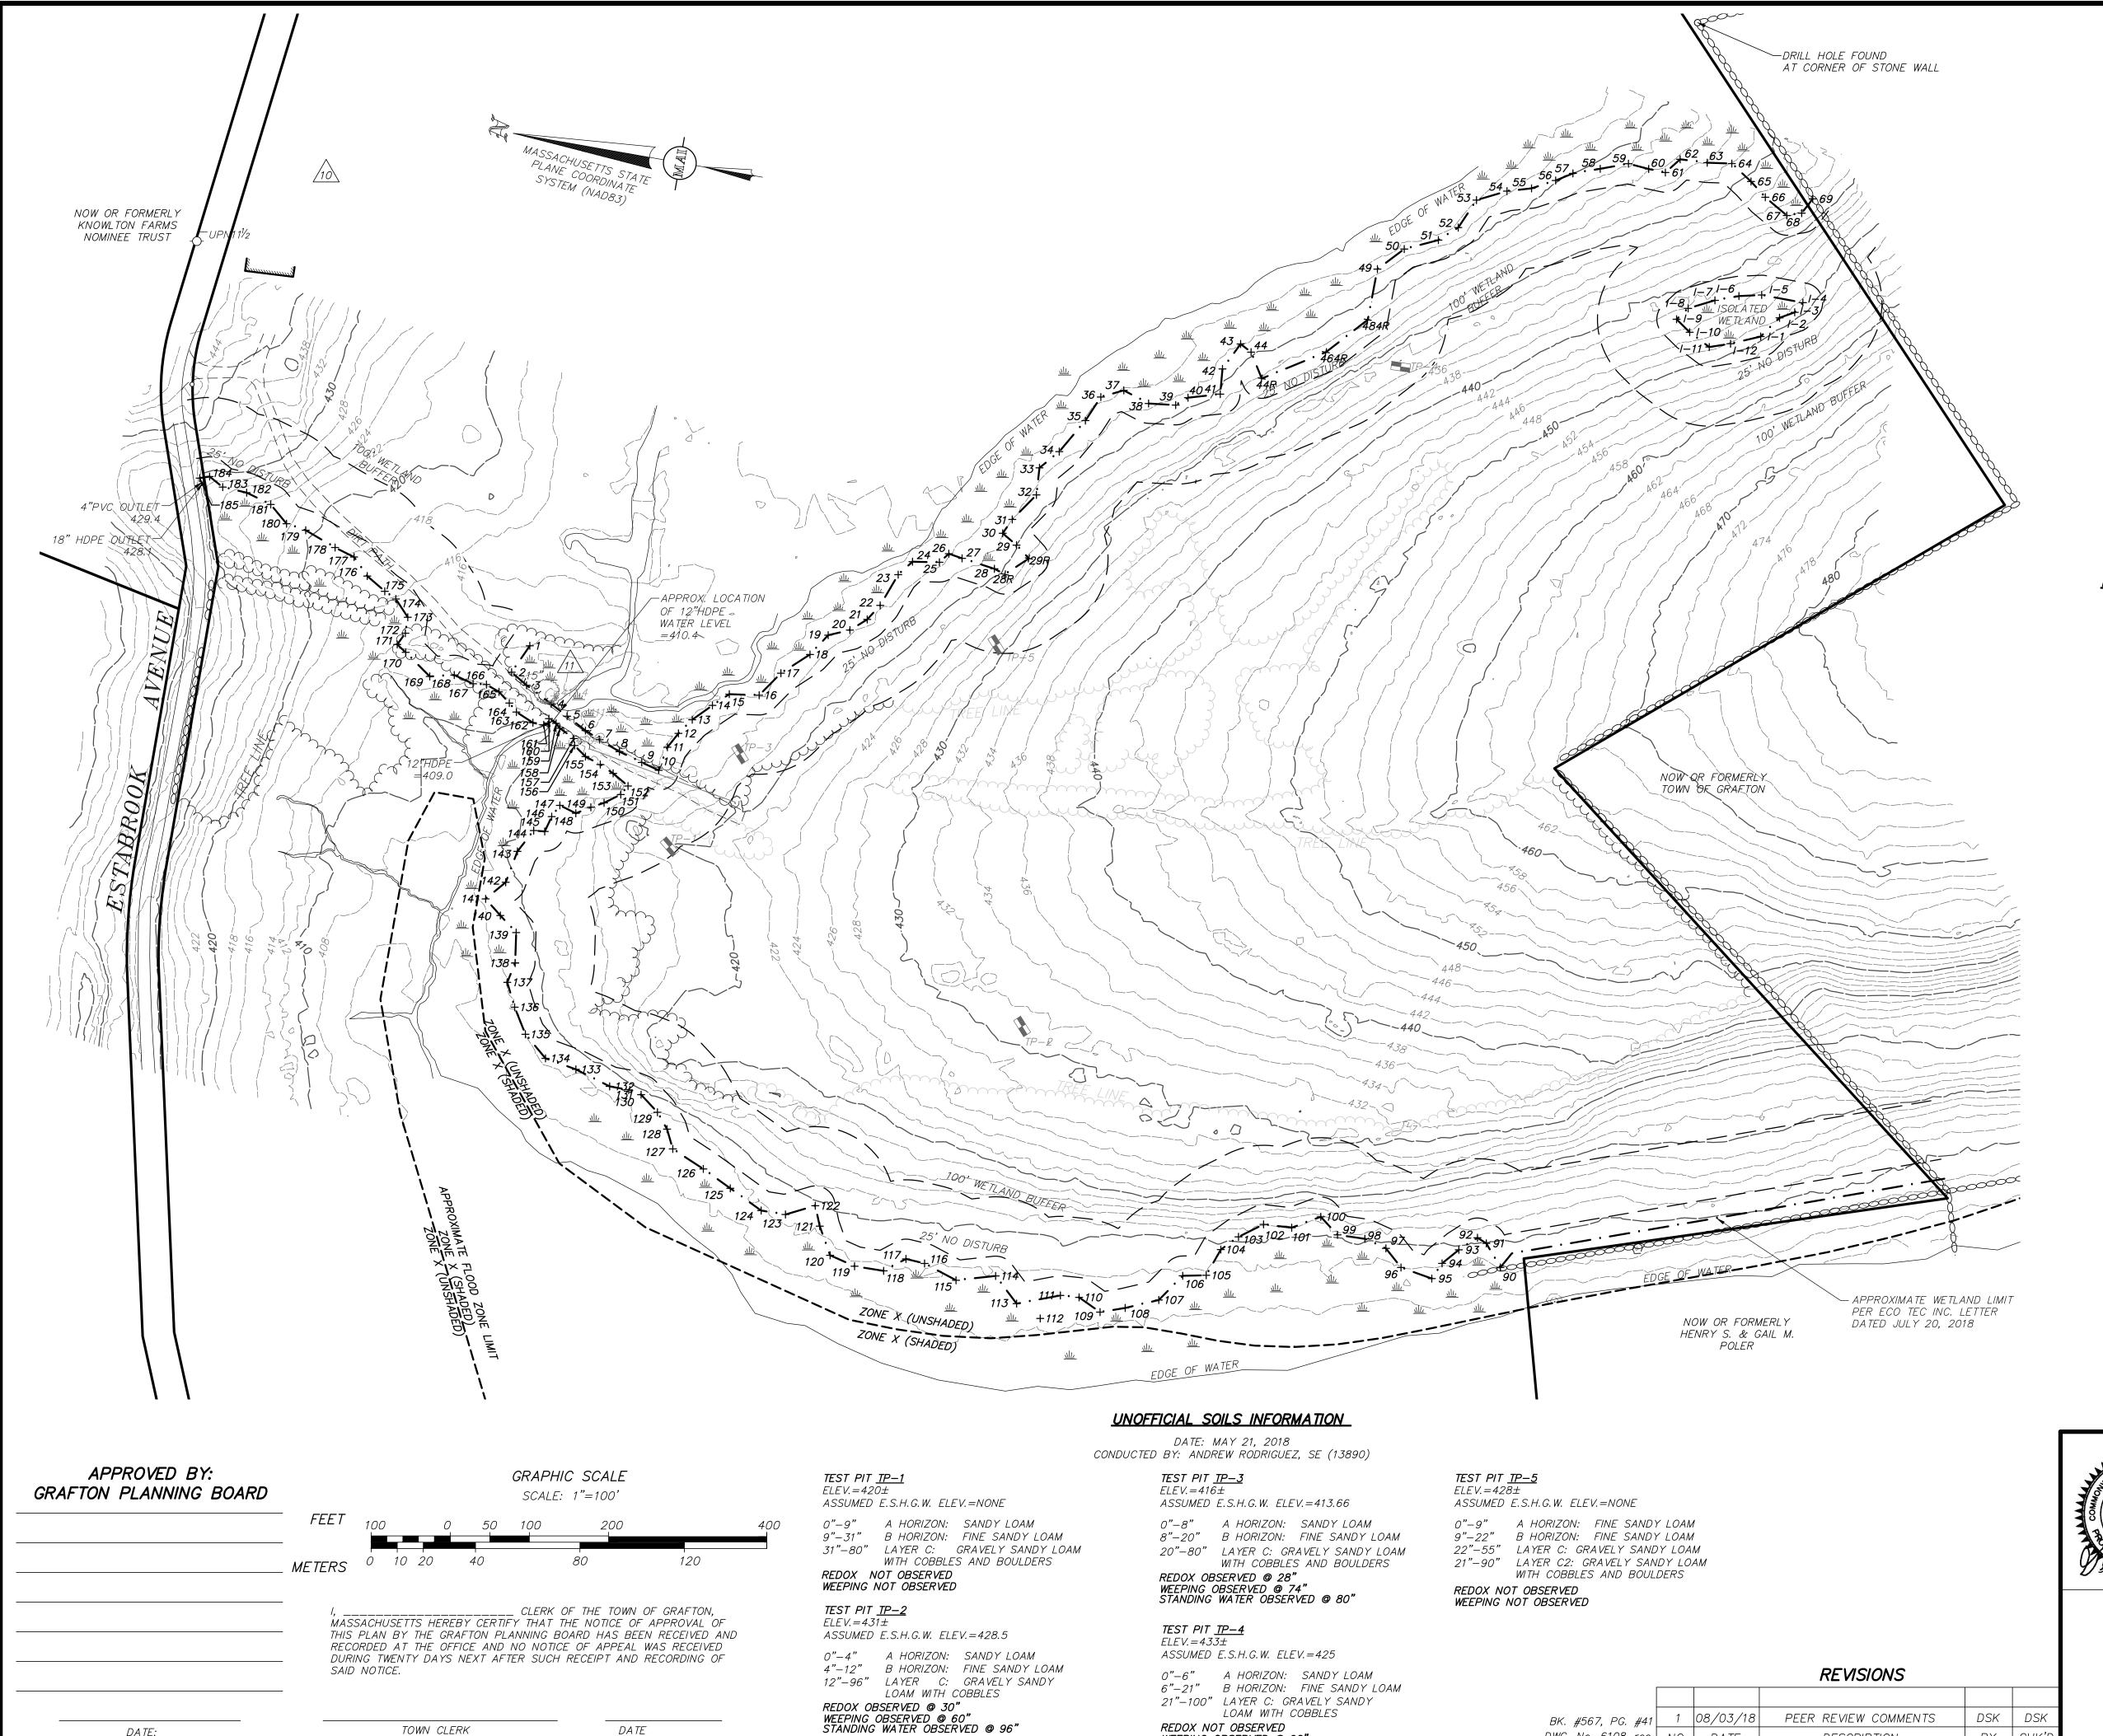

DWG FILE: 6108_rec.dwg 3:40pm PLOTTED: Jul 27, 2018 dkelley

WEEPING OBSERVED @ 96'

SCHEDULE OF DIMENSIONAL CONTROLS

ZONING DISTRICT: RESIDENTIAL (R40)

<u>REQUIRE</u>	<u>MENT</u>	<u>REQUIRED</u>	<u>PROPOSED</u>
LOT	AREA:	40,000 SF.	7,196,902 SF.
FRON	TAGE:	140 FT.	6,176 FT.
FRONT	YARD:	30 FT.	31± FT. (EX. DWELLING)
SIDE	YARD:	15 FT.	>2,000 FT. (EX. DWELLING)
REAR	YARD:	15 FT.	166± FT. (SOLAR PANELS)
BUILDING LOT COVE	RAGE:	30%	0.1%
MAXIMUM BUILDING HE	EIGHT:	35 FT.	<35 FT. (EX. DWELLING)

SITE FEATURES

----XX---- TWO FOOT CONTOUR -----XX-----FIVE FOOT CONTOUR TREELINE · STONEWALL BORDERING VEGETATED WETLANDS

WETLAND FLAG WETLAND FLAG - - LIMIT OF BUFFER ZONE

<u>TEMPORARY BENCHMARK CHART</u>

T.B.M.#	DESCRIPTION	ELE VA TION
10	CUT SPIKE IN UTILITY POLE #11 $\frac{1}{2}$, 1.5' A.G.	453.08
11	CUT SPIKE IN 15" CONIFEROUS TREE, 1.0' A.G.	413.32

(SEE NOTE 6)

NOTES:

- 1. THE TOPOGRAPHY, SITE DETAIL & SURFACE IMPROVEMENTS DEPICTED HEREON WERE OBTAINED FROM AN AERIAL LIDAR SURVEY CONDUCTED BY MERIDIAN ASSOCIATES, INC. (MAI) ON APRIL 23, 2018 AND SUPPLEMENTED WITH AN ON-THE-GROUND SURVEY CONDUCTED ON JUNE 5, 2018.
- 2. THE SUBJECT PROPERTY IS LOCATED IN THE LOW DENSITY RESIDENTIAL (R-40) ZONING DISTRICT.
- 3. THE SUBJECT PROPERTY IS DEPICTED AS PARCEL ID 110/049.0-0000-0006.0 ON TOWN OF GRAFTON ONLINE ASSESSOR'S DATABASE.
- 4. THE LOCATION OF ALL UNDERGROUND UTILITIES SHOWN ARE APPROXIMATE AND ARE BASED UPON A PARTIAL FIELD SURVEY AND COMPILATION OF PLANS OF RECORD. MERIDIAN ASSOCIATES, INC. DOES NOT WARRANTY NOR GUARANTEE THE LOCATION OF ALL UTILITIES DEPICTED OR NOT DEPICTED. THE CONTRACTOR, PRIOR TO COMMENCEMENT OF CONSTRUCTION, SHALL VERIFY THE LOCATION OF ALL UTILITIES AND CONTACT DIG SAFE AT 1-888-344-7233.
- 5. THIS PLAN DOES NOT SHOW ANY UNRECORDED OR UNWRITTEN EASEMENTS WHICH MAY EXIST. A REASONABLE AND DILIGENT ATTEMPT HAS BEEN MADE TO OBSERVE ANY APPARENT, VISIBLE USES OF THE LAND; HOWEVER, THIS DOES NOT CONSTITUTE A GUARANTEE THAT NO SUCH EASEMENTS EXIST.
- 6. THE ELEVATIONS DEPICTED HEREON ARE BASED UPON NORTH AMERICAN VERTICAL DATUM OF 1988 (NAVD88).
- 7. PROPERTY LINES DEPICTED HEREON ARE BASED ON COMPILED DEEDS AND PLANS OF RECORD. THIS PLAN IS NOT TO BE USED FOR THE RECONSTRUCTION OF BOUNDARY LINES OR FOR TITLE INSURANCE PURPOSES. ALL BOUNDARY LINES DEPICTED ARE APPROXIMATE ONLY. MAI DID NOT PERFORM A BOUNDARY RETRACEMENT SURVEY.
- 8. THE WETLAND FLAGS DEPICTED WERE DEMARCATED BY LEC ENVIRONMENTAL CONSULTANTS, INC. ON APRIL 2 & 3, 2018.
- 9. THE SUBJECT PROPERTY IS LOCATED IN FLOOD ZONE X (UNSHADED), AREAS DETERMINED TO BE OUTSIDE THE 0.2% ANNUAL CHANCE FLOODPLAIN, AND FLOOD ZONE X (SHADED), MODERATE RISK AREAS WITHIN THE 0.2% CHANCE FLOODPLAIN, AREAS OF 1% ANNUAL CHANCE FLOODING WHERE AVERAGE DEPTHS ARE LESS THAN 1 FOOT, AREAS OF THE 1% ANNUAL CHANCE FLOOD WHERE THE CONTRIBUTING DRAINAGE AREA IS LESS THAN 1 SQUARE MILE, AND AREAS PROTECTED FROM THE 1% ANNUAL CHANCE FLOOD BY A LEVEE PER FEMA FLOOD INSURANCE RATE MAP NUMBER 25027C0831E DATED JULY 4, 2011.
- 10. THE SUBJECT SITE IS LOCATED WITHIN THE MISCOE, WARREN AND WHITEHALL WATERSHEDS AREA OF CRITICAL AND ENVIRONMENTAL CONCERN AS DESIGNATED BY THE MASSACHUSETTS DEPARTMENT OF CONSERVATION AND RECREATION.
- 11. THE EXISTING SITE IS COMPRISED OF WOODLAND AND AGRICULTURAL FIELDS AND IS PRESENTLY USED FOR AGRICULTURAL PURPOSES.


ALL UNDERGROUND UTILITY DATA REPRESENTS RECORD INFORMATION RECOVERED THROUGH RESEARCH WITHOUT SURFACE DEMARCATION NOR SUBSURFACE VERIFICATION

RECORD OWNER:

KNOWLTON FARMS NOMINEE TRUST LEEROY E. KNOWLTON, TRUSTEE 43 ESTABROOK AVENUE GRAFTON, MASSACHUSETTS 01519

- DEED BOOK 35401 PAGE 337

44 ESTABROOK AVENUE

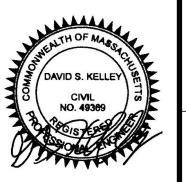

BY CHK'E

DESCRIPTION

DWG. No. 6108_rec NO. DATE

RECORD CONDITIONS PLAN OF LAND LOCATED IN GRAFTON, MASSACHUSETTS

(WORCESTER COUNTY)

PREPARED FOR BLUEWAVE CAPITAL, LLC


SCALE: 1" = 100"

DATE: JUNE 12, 2018



SHEET No. 2 OF 14 PROJECT No. 6108

BEVERLY, MASSACHUSETTS 01915 WESTBOROUGH, MASSACHUSETTS 01581 TELEPHONE: (978) 299-0447 TELEPHONE: (508) 871-7030

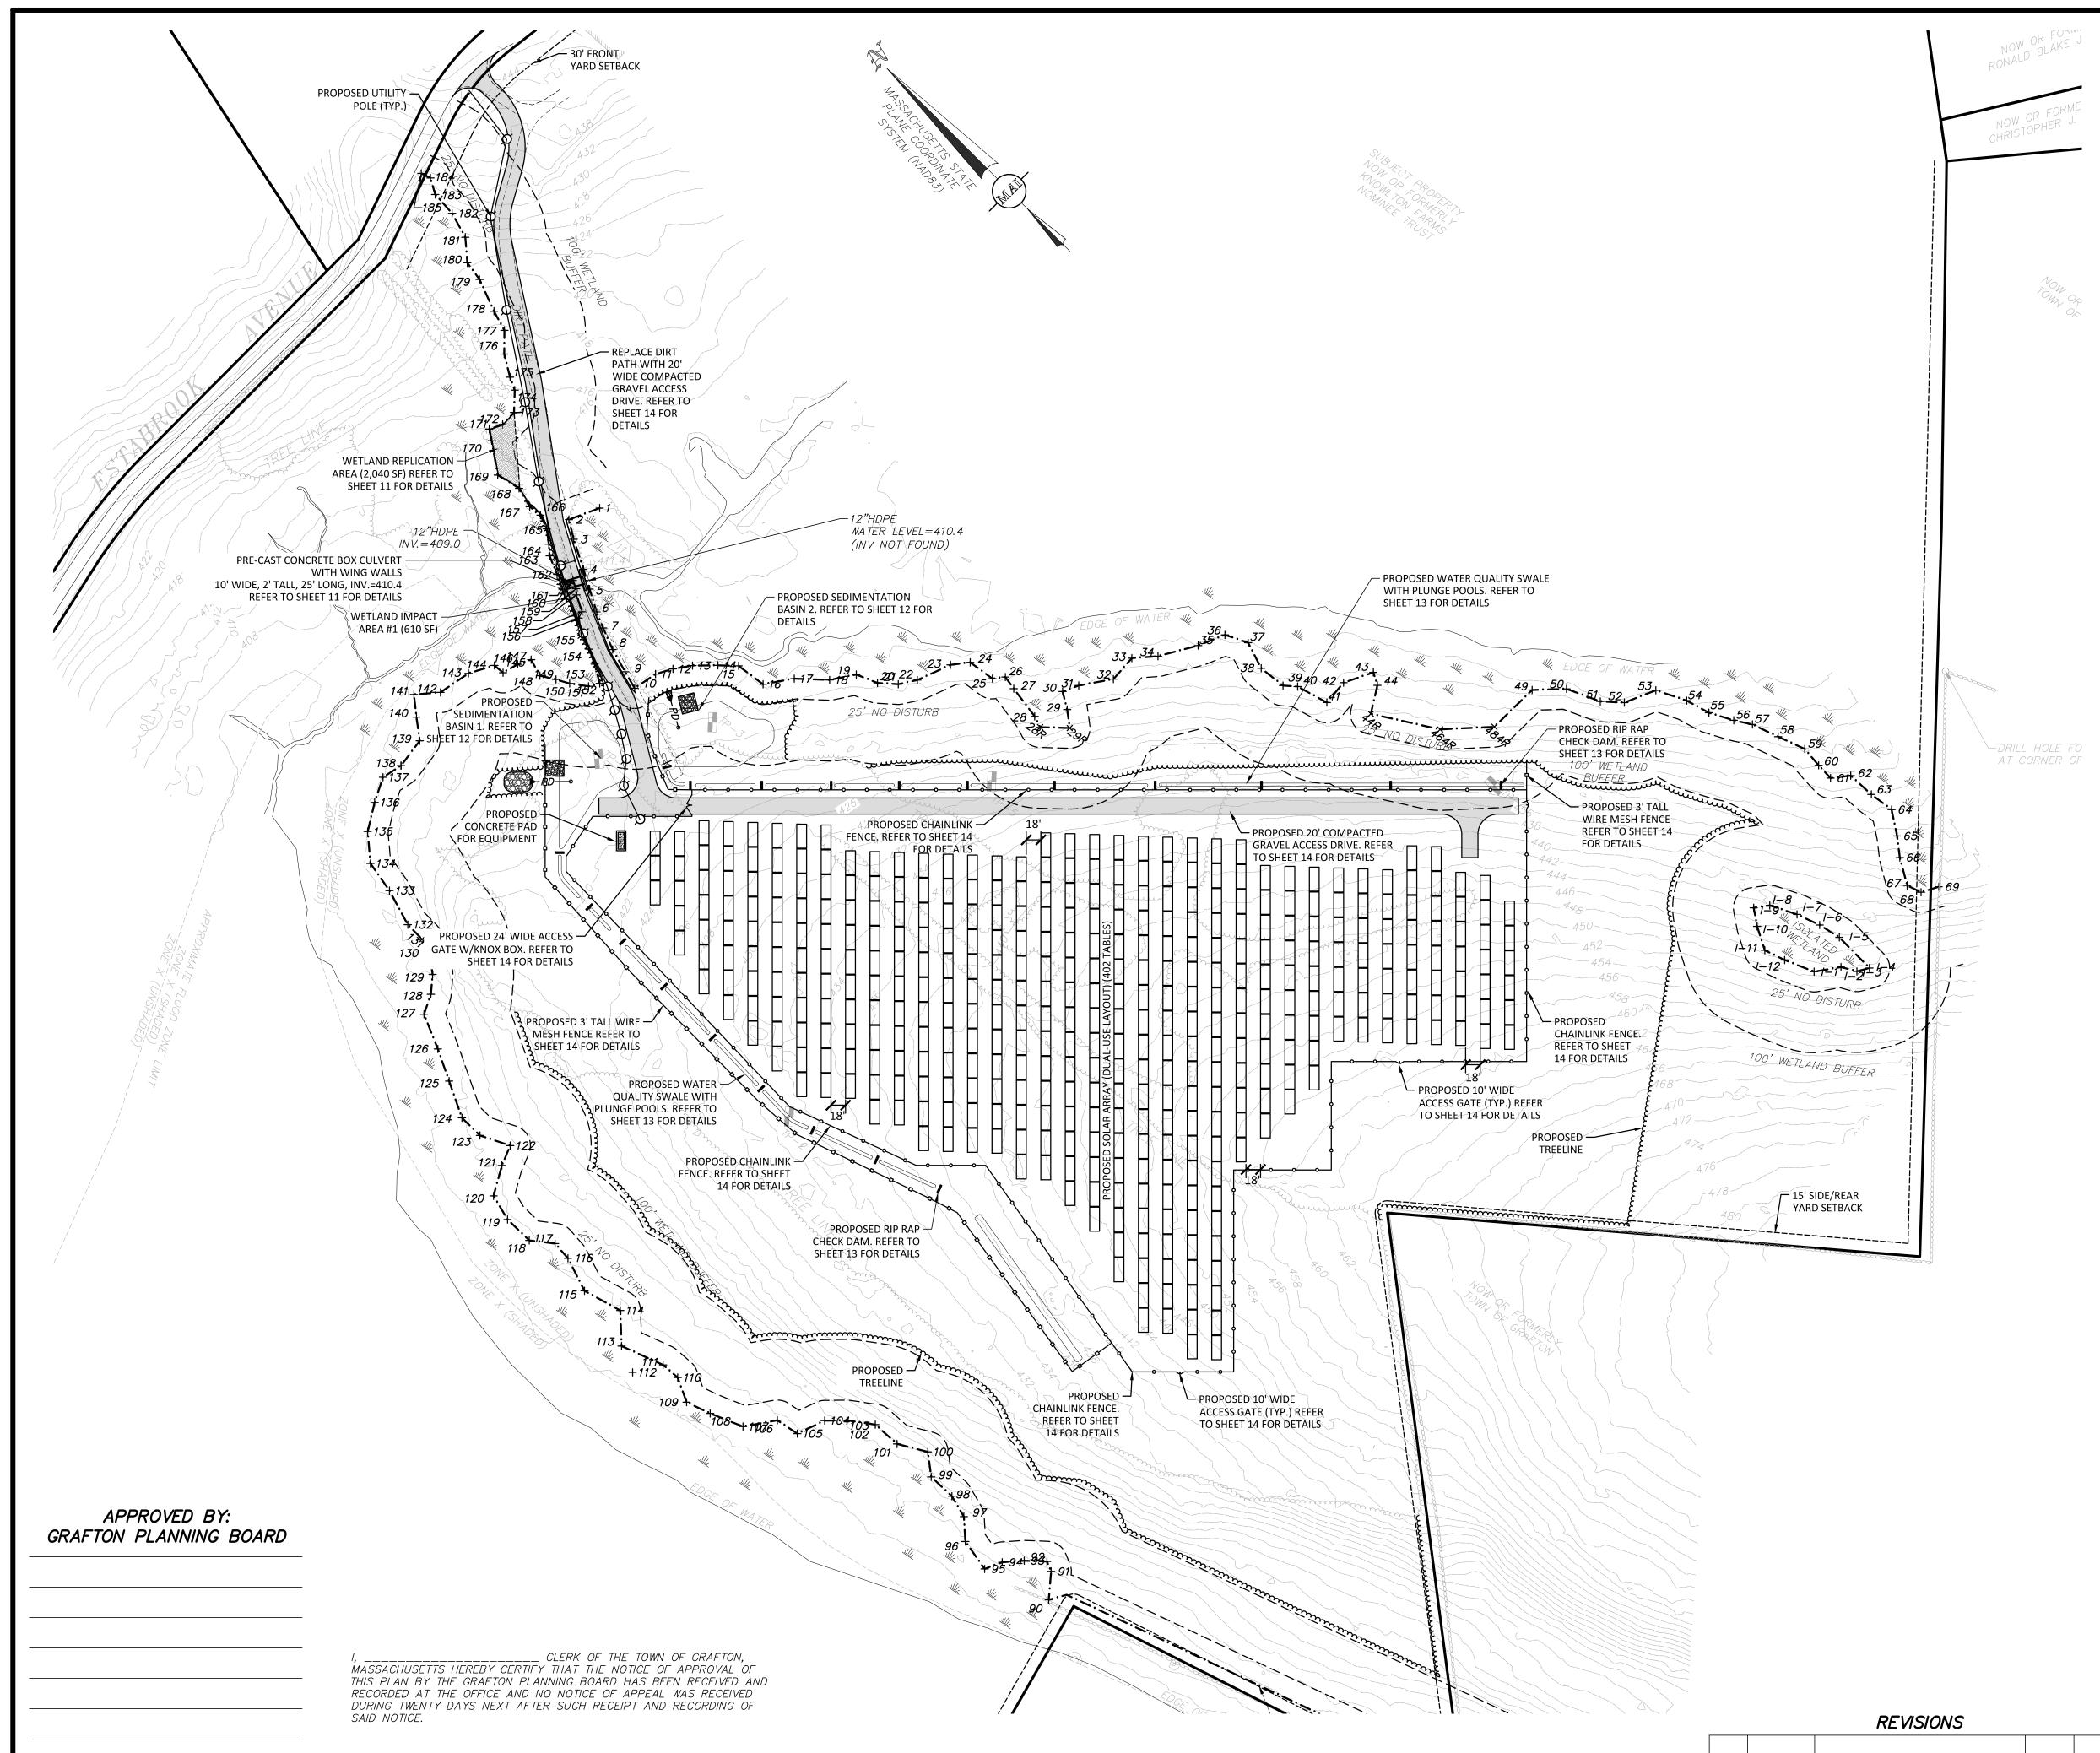

THE PROPOSED ACCESS PATHS SHALL BE VEGETATED USING "NEW ENGLAND CONSERVATIONS/WILDLIFE MIX", OR APPROVED EQUAL, AND IS INTENDED TO PROVIDE A LEVEL PATH OF TRAVEL FOR MAINTENANCE VEHICLES

FOR PERMITTING ONLY
NOT FOR CONSTRUCTION

SEE SHEET 2 OF 12 FOR GENERAL NOTES AND LEGEND

MODULES	DC POWER
7,236	2.9±MW

<u>NOTES:</u>

- 1. THE PROPOSED PROJECT WILL CONSIST OF A LARGE SCALE GROUND MOUNTED SOLAR FARM WITH AGRICULTURAL USES I.E. "DUAL-USE".
- 2. THE PROPOSED PROJECT DOES NOT INCLUDED IMPERVIOUS AREAS OTHER THAN THE 150 SF CONCRETE PAD FOR THE ELECTRICAL EQUIPMENT. THE SITE IS PRESENTLY OPEN SPACE, AND WILL REMAIN AS OPEN SPACE WITH GROUND MOUNTED SOLAR
- 3. THERE IS NO PROPOSED PARKING AS THE SITE WILL ONLY BE ACCESSED FOR MAINTENANCE AND REPAIRS TO THE SOLAR PANELS AND EQUIPMENT. THERE WILL NOT BE PERSONAL ONSITE ON A REGULAR BASIS.
- 4. THE SOLAR PANEL TABLES ARE TO BE LAID OUT AS TO PROVIDE EIGHTEEN (18) FEET OF CLEAR SPACE BETWEEN EACH ROW.
- 5. THERE IS TO BE NO PARKING ALONG ESTABROOK AVENUE DURING THE CONSTRUCTION OF THE PROJECT.
- 6. REFER TO EROSION CONTROL PLAN FOR ADDITIONAL NOTES REGARDING CONSTRUCTION SEQUENCING.

<u>LEGEND:</u>

	- TWO FOOT CONTOUR - TEN FOOT CONTOUR = BITUMINOUS BERM ■ GRANITE CURB = CONCRETE CURB → TREELINE → SCRUB LINE - STEEL GUARDRAIL - WIRE FENCE REMAINS → STONEWALL ■ EXPOSED ROCK OUTCROP
	SIGN
\bigoplus	WITNESS POST
	SHRUB
	TREE
+A14	_BORDERING VEGETATED WETLANDS WETLAND FLAG
— — — — — — — — — — — — — — — — — — —	- LIMIT OF BUFFER ZONE
———ОНW——	- OVERHEAD WIRES
————E———	- ELECTRIC LINE
	UTILITY POLE
(GUY WIRE
E	ELECTRIC BOX
<u>(D)</u>	DRAIN MANHOLE
	CATCH BASIN BOULDER
	TERMINUS UNKNOWN
BB	BITUMINOUS BERM
BIT. CONC.	BITUMINOUS CONCRETE
CC	CONCRETE CURB
EOP	EDGE OF PAVEMENT
GC UGE	GRANITE CURB UNDERGROUND ELECTRIC
UGE	UNDENGROUND ELECTRIC

PROPOSED LEGEND:

~~~~~~~ PROPOSED	TREELINE
——————————————————————————————————————	CONTOUR
<b>────</b> <i>PROPOSED</i>	CHAINLINK FENCE
<del> </del>	WIRE MESH FENCE
PE PROPOSED	UNDERGROUND ELECTRIC LIN
——POHW——PROPOSED	OVERHEAD WIRES
• PROPOSED	UTILITY POLE

GRAPHIC SCALE

SCALE: 1"=100'

FEET 100 0 50 100 200

44 ESTABROOK AVENUE

PERMIT SITE PLAN OF LAND (DUAL-USE)

LOCATED IN

# GRAFTON, MASSACHUSETTS

(WORCESTER COUNTY)

PREPARED FOR
BLUEWAVE CAPITAL, LLC

SCALE: 1"= 100' DATE: JUNE 12, 2018



500 CUMMINGS CENTER, SUITE 5950
BEVERLY, MASSACHUSETTS 01915
TELEPHONE: (978) 299-0447

TELEPHONE: (508) 871-7030

SHEET No. 3 OF 14

BK. #567, PG. #41 1 08/03/18

DWG. No. 6108_SITE NO. DATE

PEER REVIEW COMMENTS

DESCRIPTION

DSK DSK


BY CHK'L

TELEPHONE: (978) 299-0447 TELEPHONE: (508) 871-7030 WWW.MERIDIANASSOC.COM

No. 3 OF 14 PROJECT No. 6108

TOWN CLERK

DATE

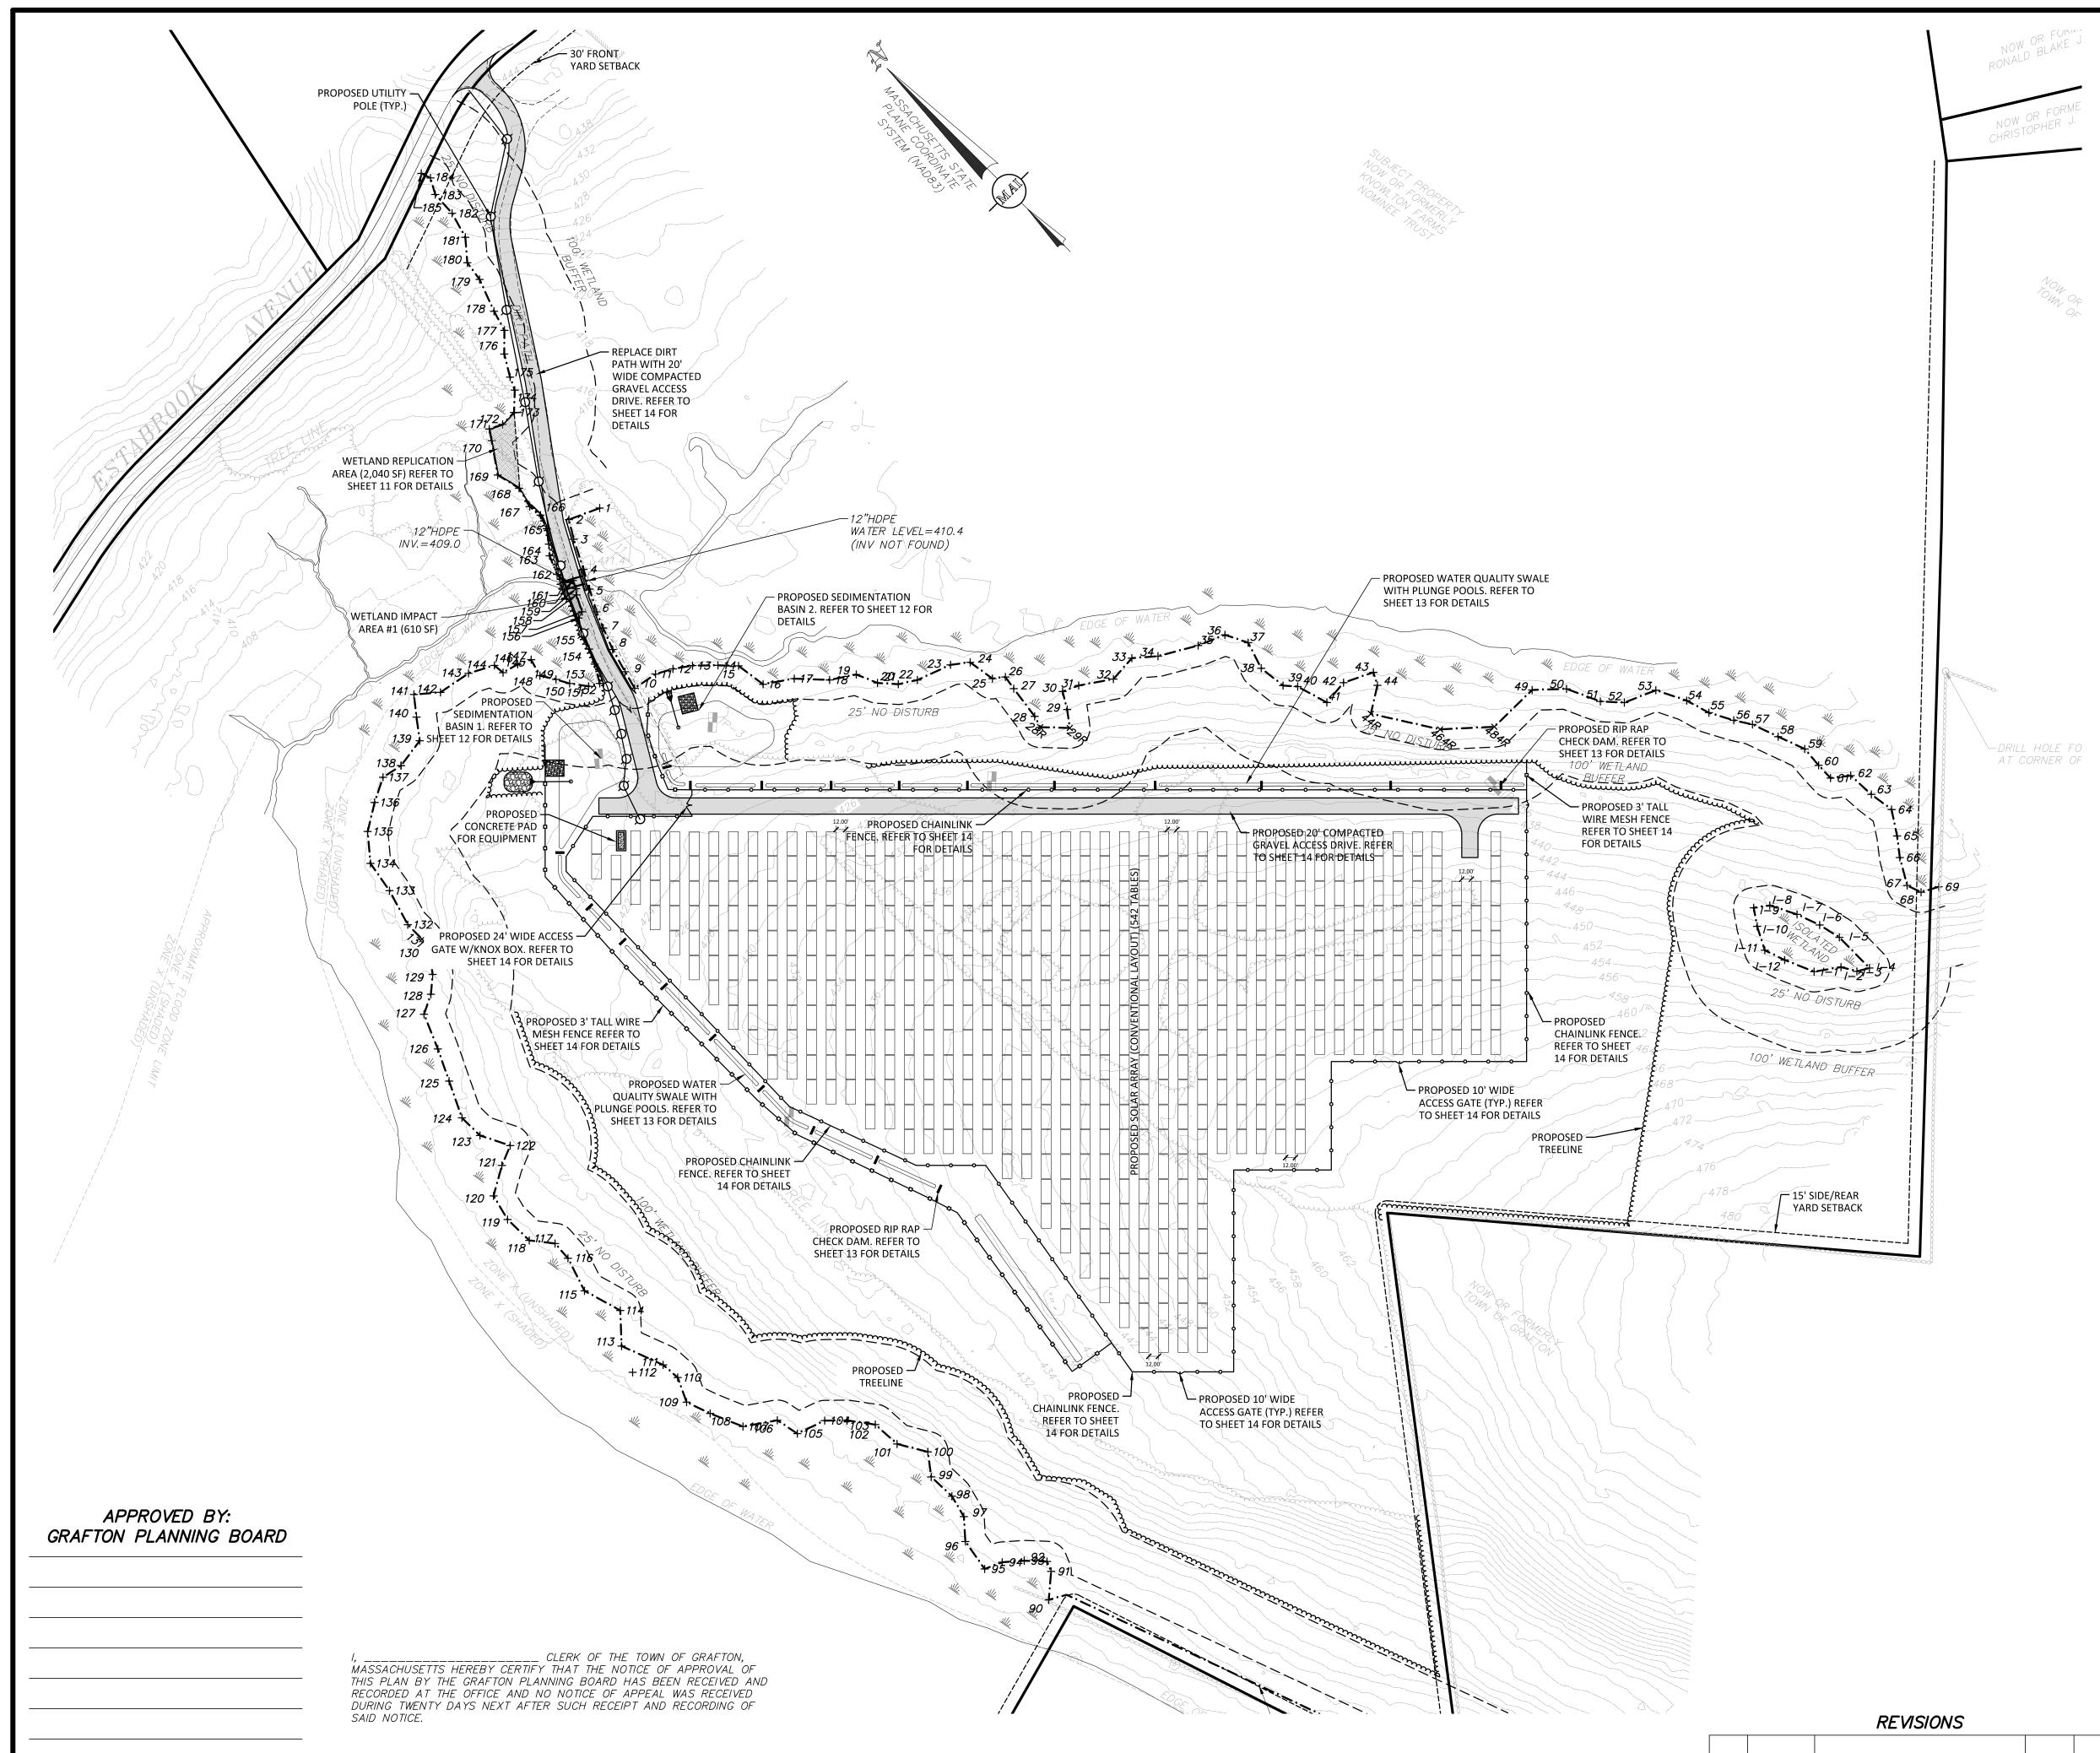

THE PROPOSED ACCESS PATHS SHALL BE VEGETATED USING "NEW ENGLAND CONSERVATIONS/WILDLIFE MIX", OR APPROVED EQUAL, AND IS INTENDED TO PROVIDE A LEVEL PATH OF TRAVEL FOR MAINTENANCE VEHICLES

FOR PERMITTING ONLY NOT FOR CONSTRUCTION

SEE SHEET 2 OF 12 FOR GENERAL NOTES AND LEGEND

MODULES DC POWER  $3.9\pm MW$ 

### NOTES:

- 1. THE PROPOSED PROJECT WILL CONSIST OF A LARGE SCALE GROUND MOUNTED SOLAR FARM WITH A CONVENTIONAL LAYOUT.
- 2. THE PROPOSED PROJECT DOES NOT INCLUDED IMPERVIOUS AREAS OTHER THAN THE 150 SF CONCRETE PAD FOR THE ELECTRICAL EQUIPMENT. THE SITE IS PRESENTLY OPEN SPACE, AND WILL REMAIN AS OPEN SPACE WITH GROUND MOUNTED SOLAR
- 3. THERE IS NO PROPOSED PARKING AS THE SITE WILL ONLY BE ACCESSED FOR MAINTENANCE AND REPAIRS TO THE SOLAR PANELS AND EQUIPMENT. THERE WILL NOT BE PERSONAL ONSITE ON A REGULAR BASIS.
- 4. THE SOLAR PANEL TABLES ARE TO BE LAID OUT AS TO PROVIDE TWELVE (12) FEET OF CLEAR SPACE BETWEEN EACH ROW.
- 5. THE PURPOSE OF THIS PLAN IS TO DEPICT WHAT A CONVENTIONAL SOLAR ARRAY WOULD LOOK LIKE SHOULD THE 'DUAL-USE' LAYOUT NOT BE UTILIZED.

### **LEGEND:**

710	TWO FOOT CONTOUR TEN FOOT CONTOUR BITUMINOUS BERM CONCRETE CURB TREELINE SCRUB LINE STEEL GUARDRAIL WIRE FENCE REMAINS STONEWALL EXPOSED ROCK OUTCROP SPOIL PILE SIGN WITNESS POST SHRUB
Example of the second	TREE
<del>+</del> A14	BORDERING VEGETATED WETLANDS WETLAND FLAG LIMIT OF BUFFER ZONE OVERHEAD WIRES ELECTRIC LINE UTILITY POLE GUY WIRE ELECTRIC BOX DRAIN MANHOLE CATCH BASIN BOULDER TERMINUS UNKNOWN BITUMINOUS BERM BITUMINOUS CONCRETE CONCRETE CURB EDGE OF PAVEMENT GRANITE CURB UNDERGROUND ELECTRIC

# PROPOSED LEGEND:

	TREELINE
——————————————————————————————————————	CONTOUR
<b>────</b> <i>PROPOSED</i>	CHAINLINK FENCE
——————————————————————————————————————	WIRE MESH FENCE
PE PROPOSED	UNDERGROUND ELECTRIC LINE
POHWPROPOSED	OVERHEAD WIRES
•O PROPOSED	UTILITY POLE

GRAPHIC SCALE SCALE: 1"=100' 0 50 100



PERMIT SITE PLAN OF LAND (CONVENTIONAL)

LOCATED IN GRAFTON, MASSACHUSETTS (WORCESTER COUNTY)

PREPARED FOR

BLUEWAVE CAPITAL, LLC SCALE: 1"= 100' DATE: JUNE 12, 2018

TELEPHONE: (978) 299-0447 TELEPHONE: (508) 871-7030 WWW.MERIDIANASSOC.COM

BEVERLY, MASSACHUSETTS 01915 WESTBOROUGH, MASSACHUSETTS 01581

SHEET No. 4 OF 14

BK. #567, PG. #41 1 08/03/18

DWG. No. 6108_SITE NO. DATE

PEER REVIEW COMMENTS

DESCRIPTION

DSK DSK


BY CHK'L


PROJECT No. 6108


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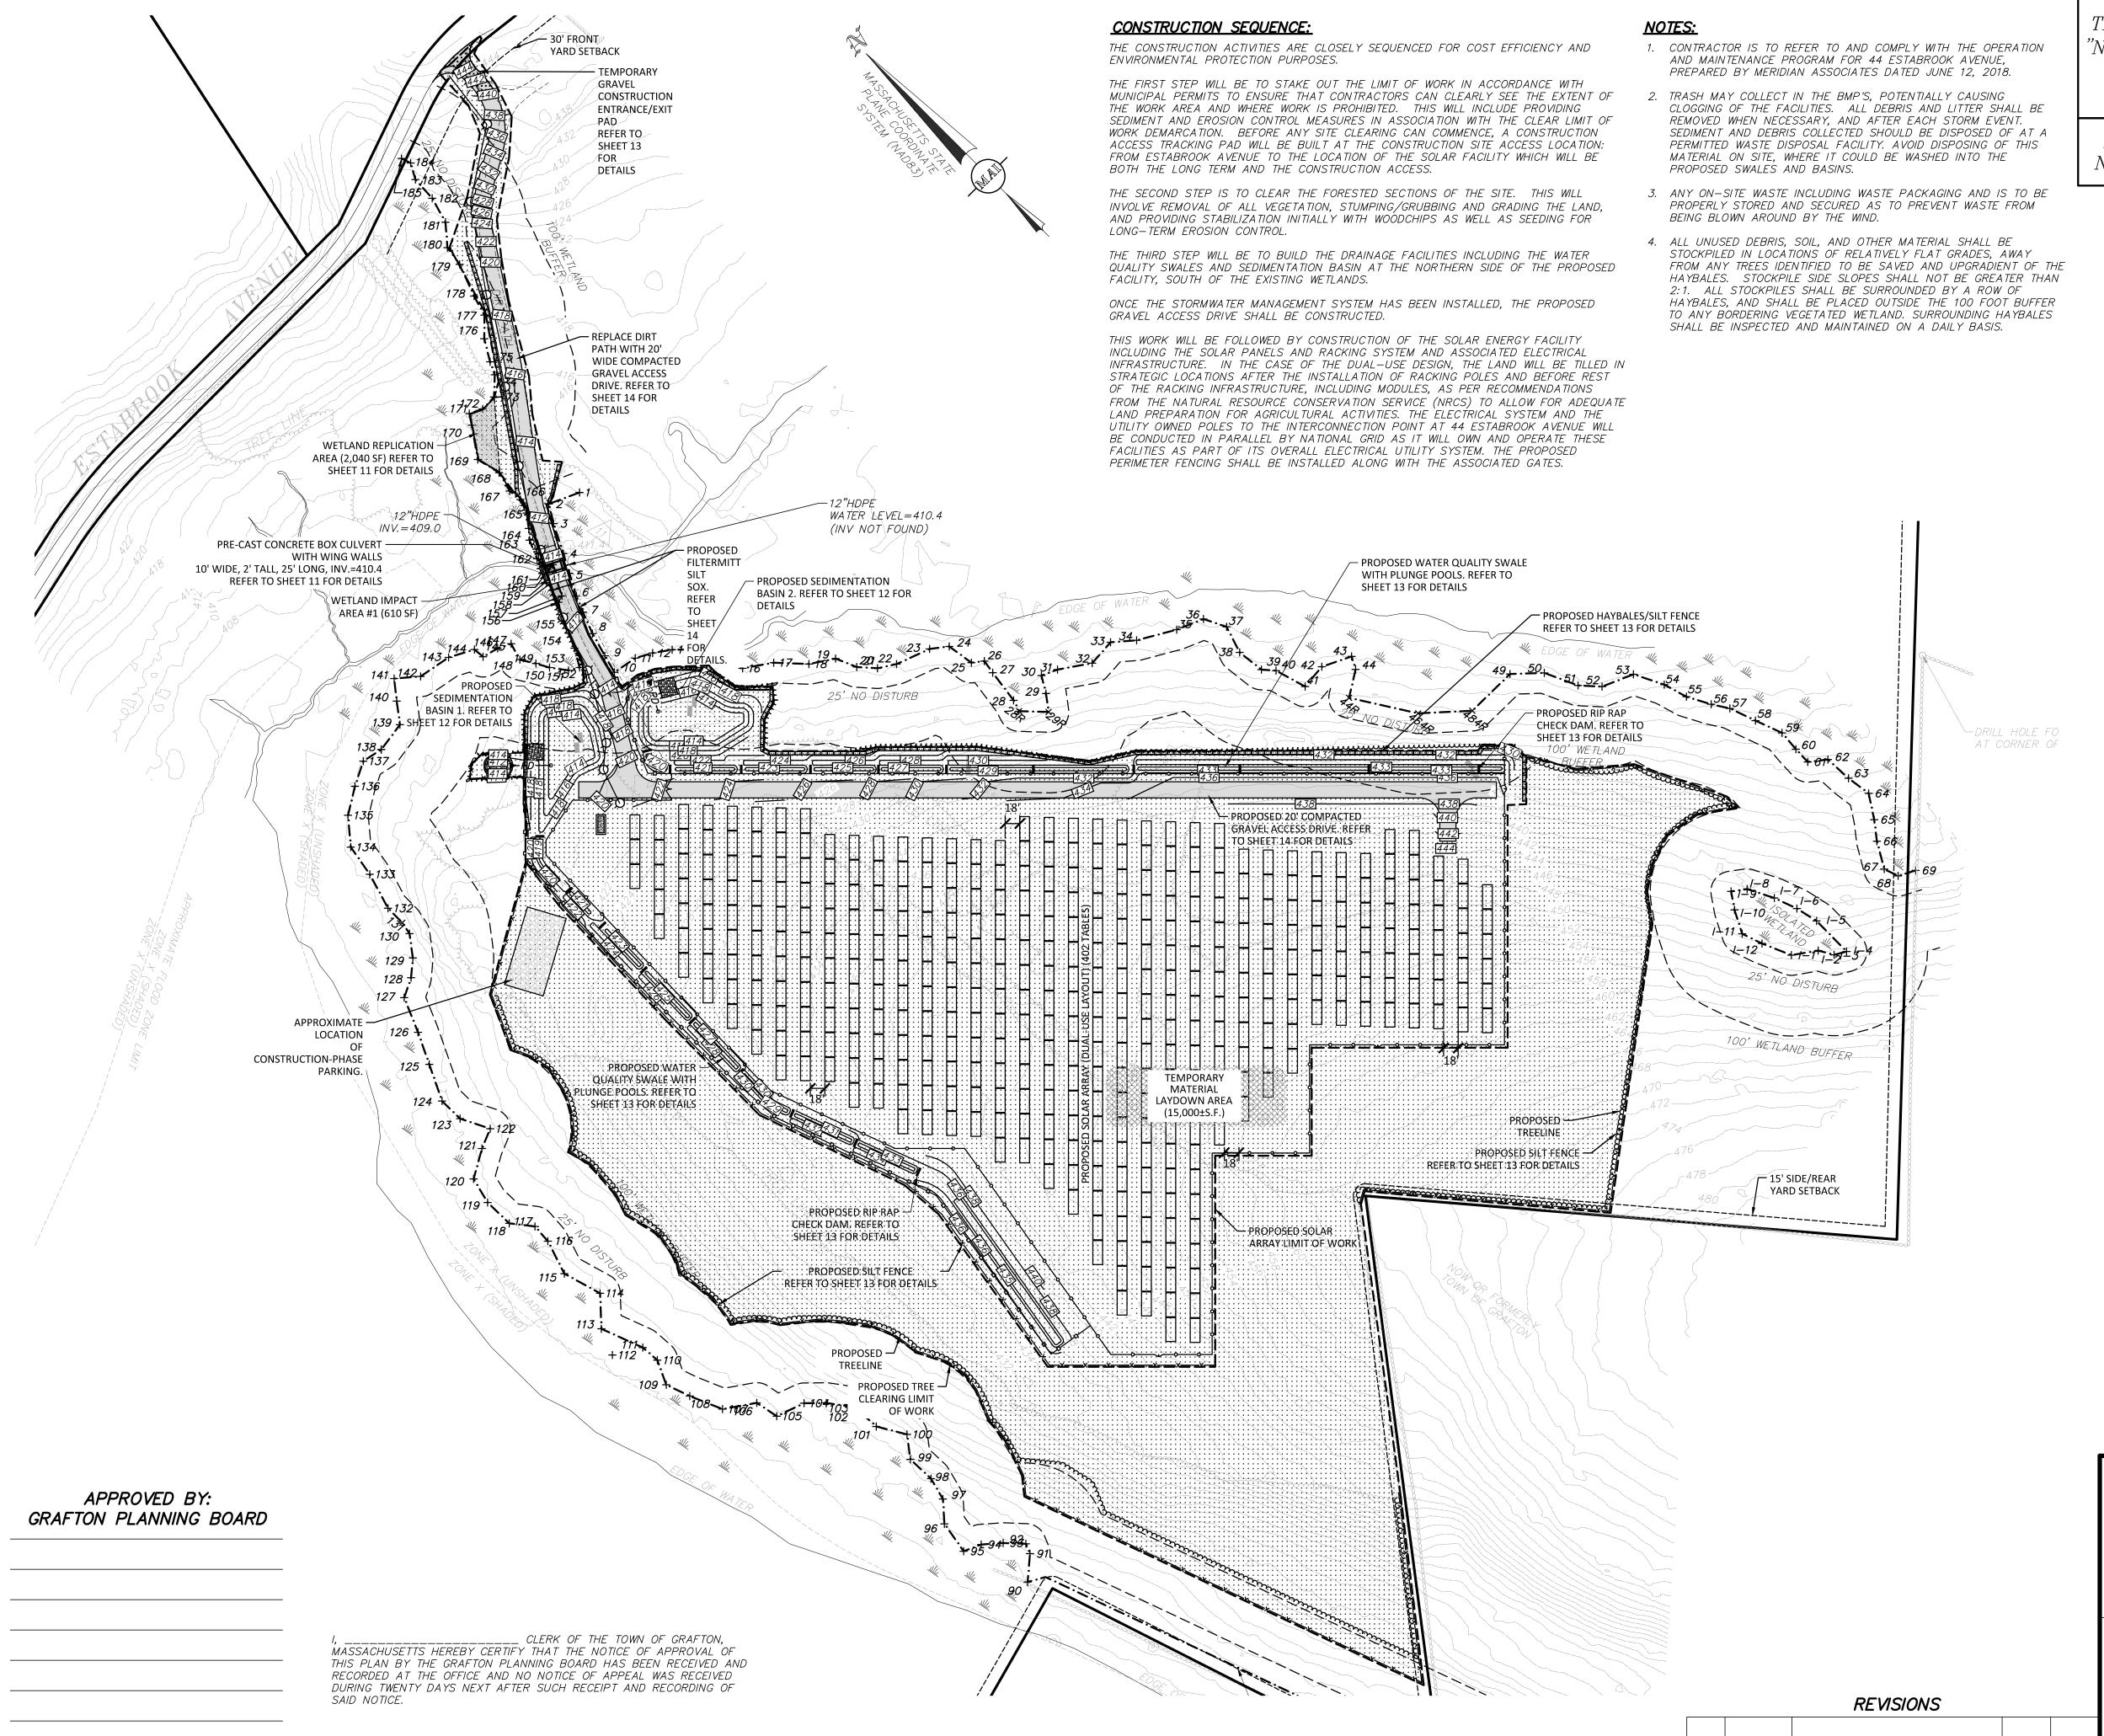
TOWN CLERK

DATE



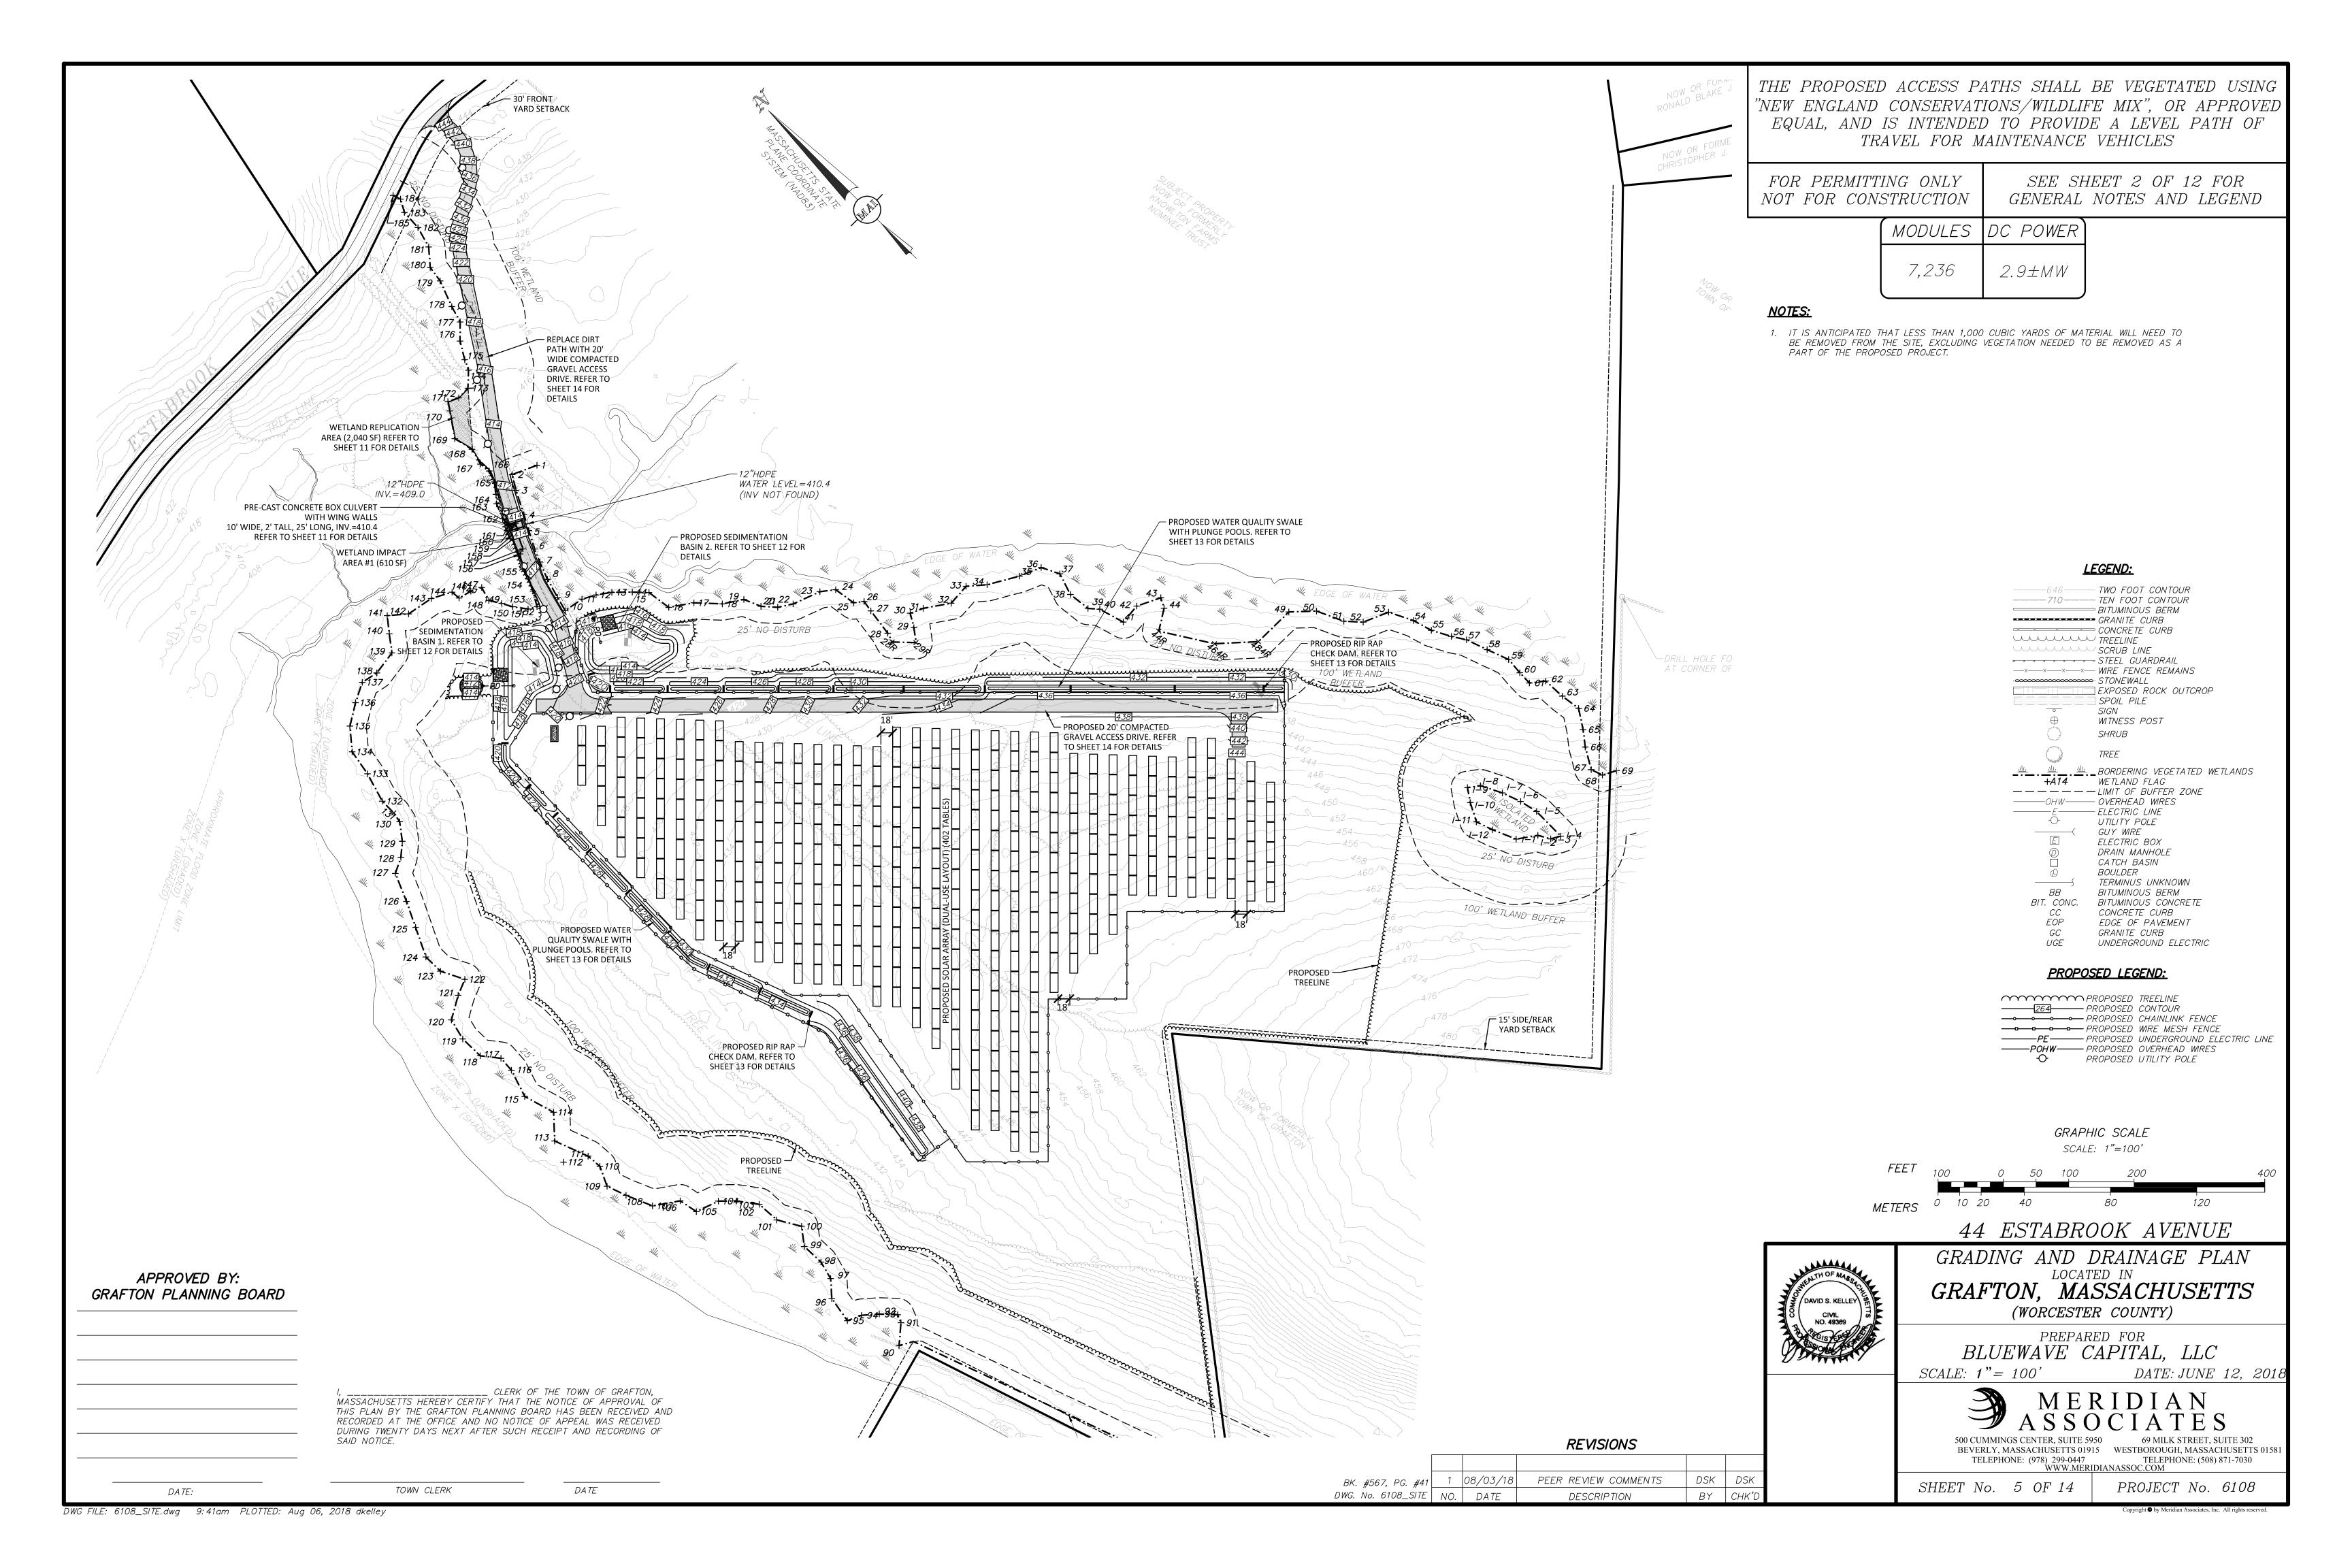

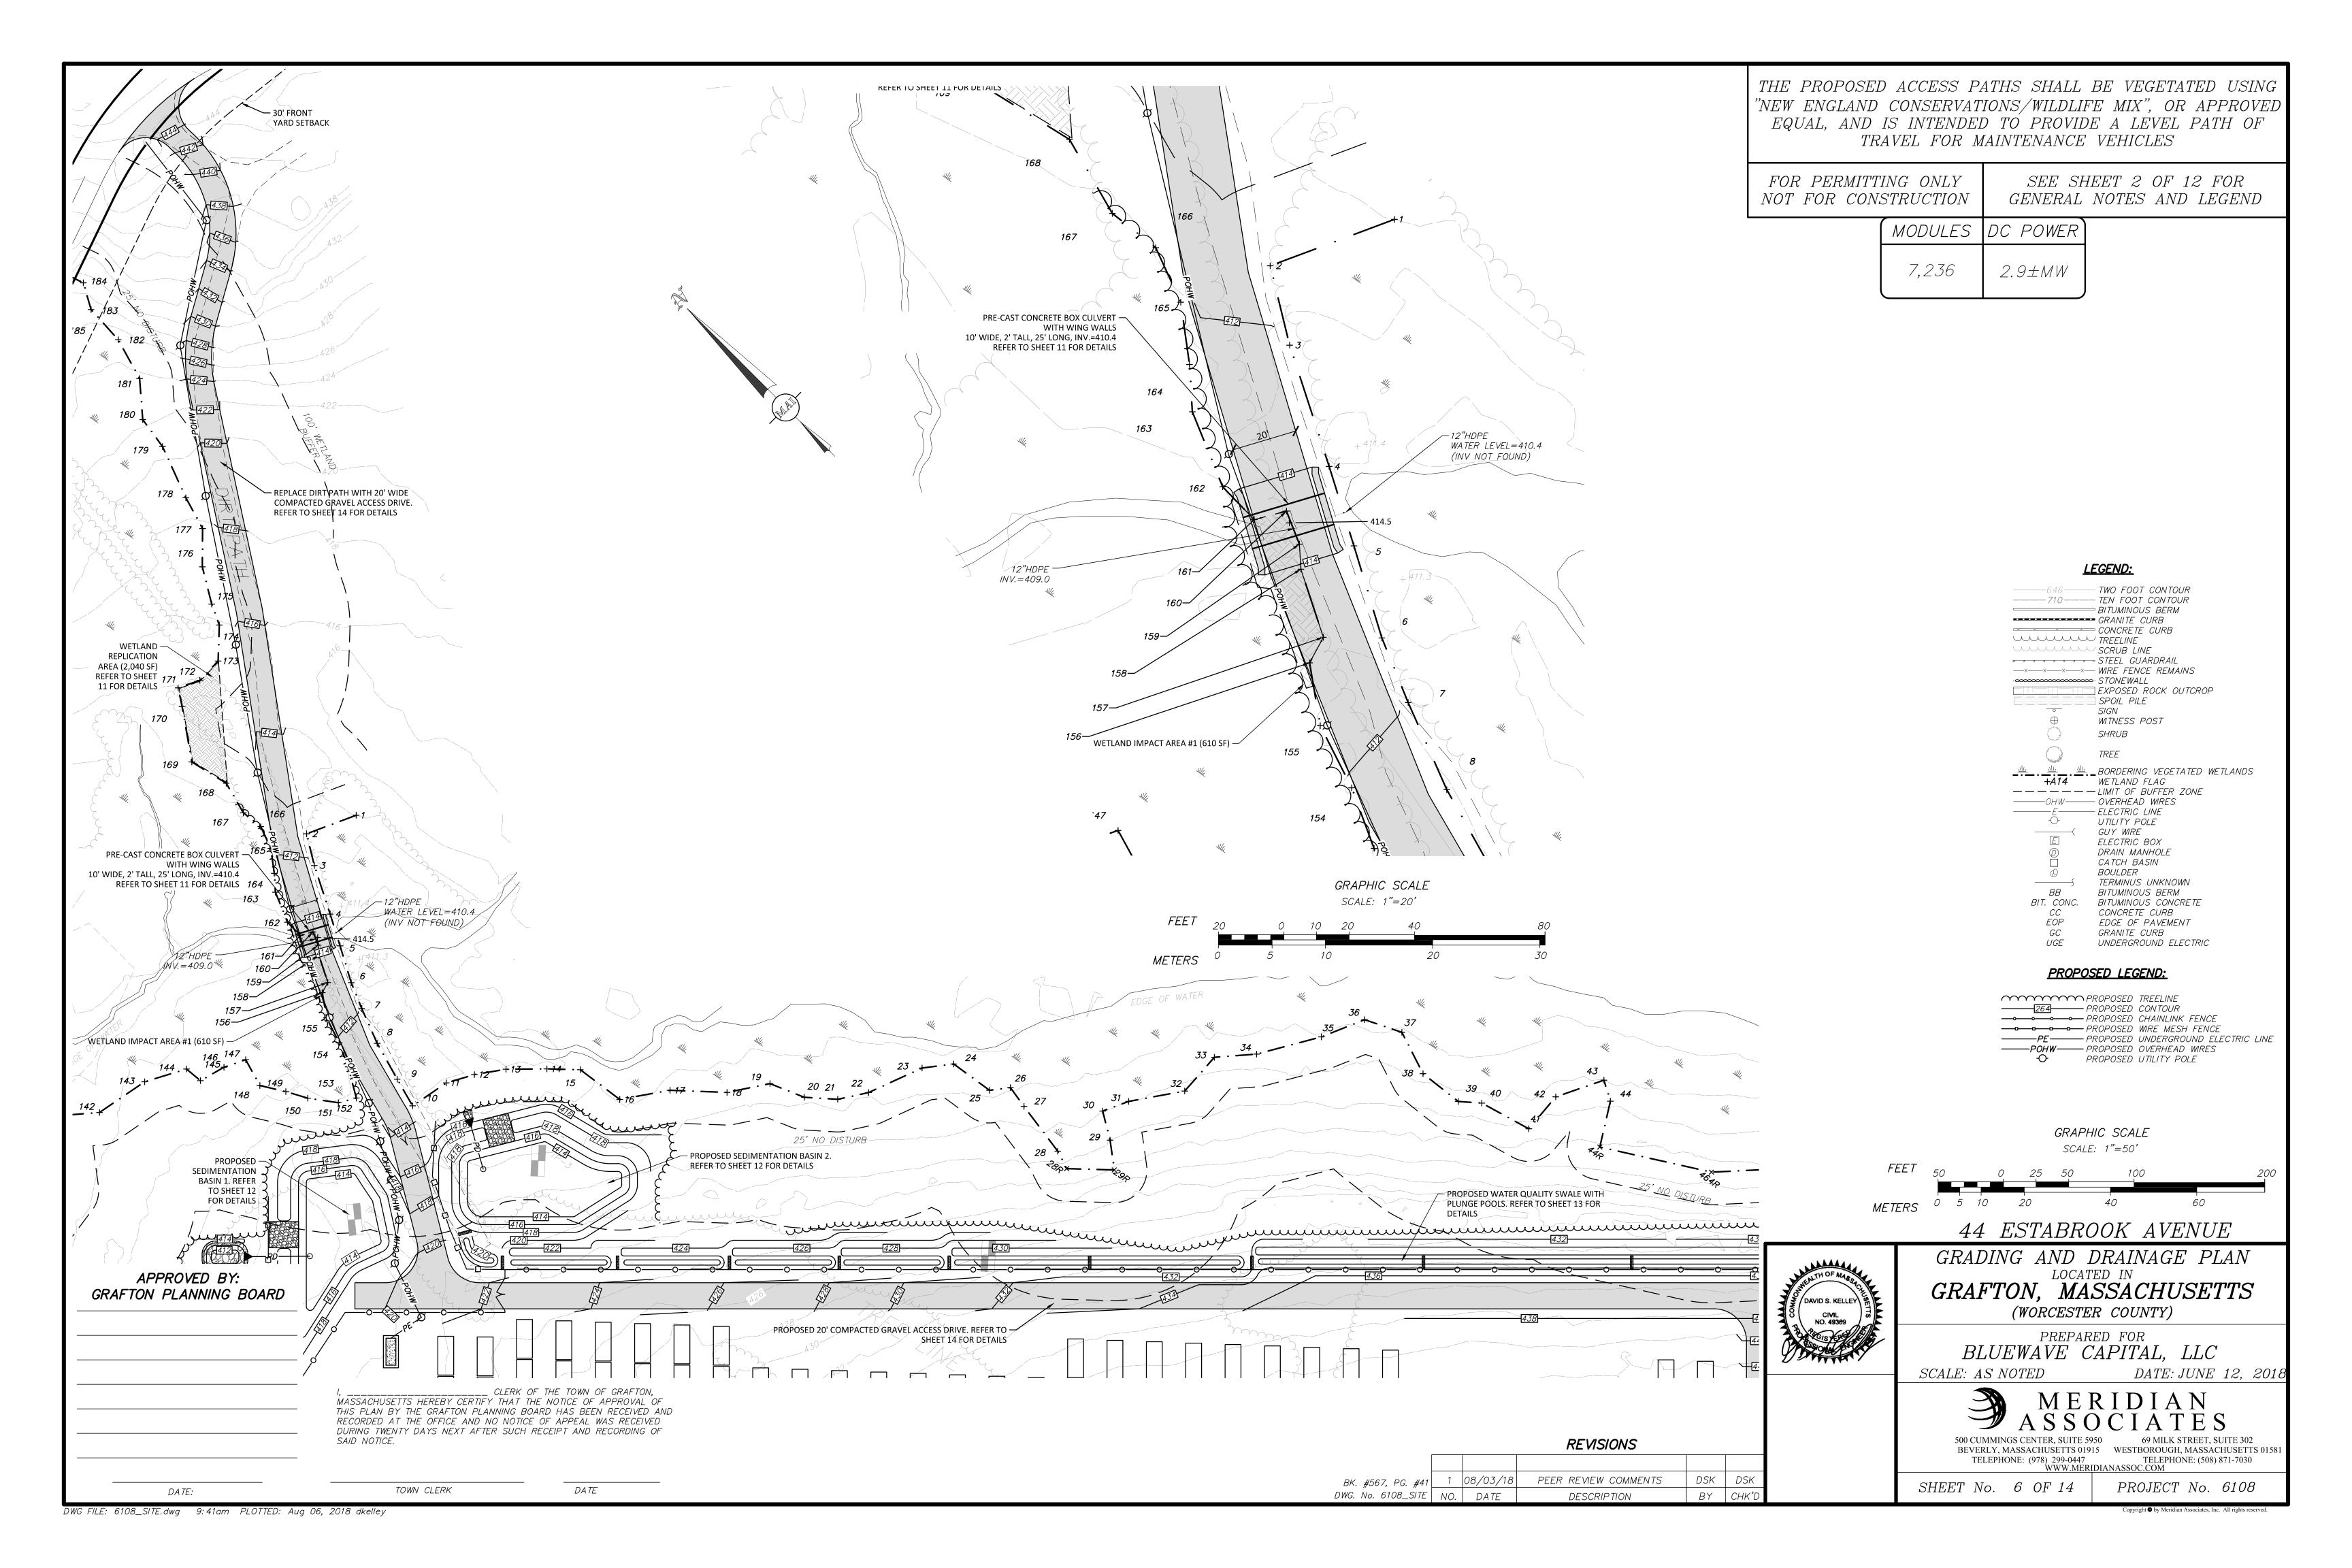

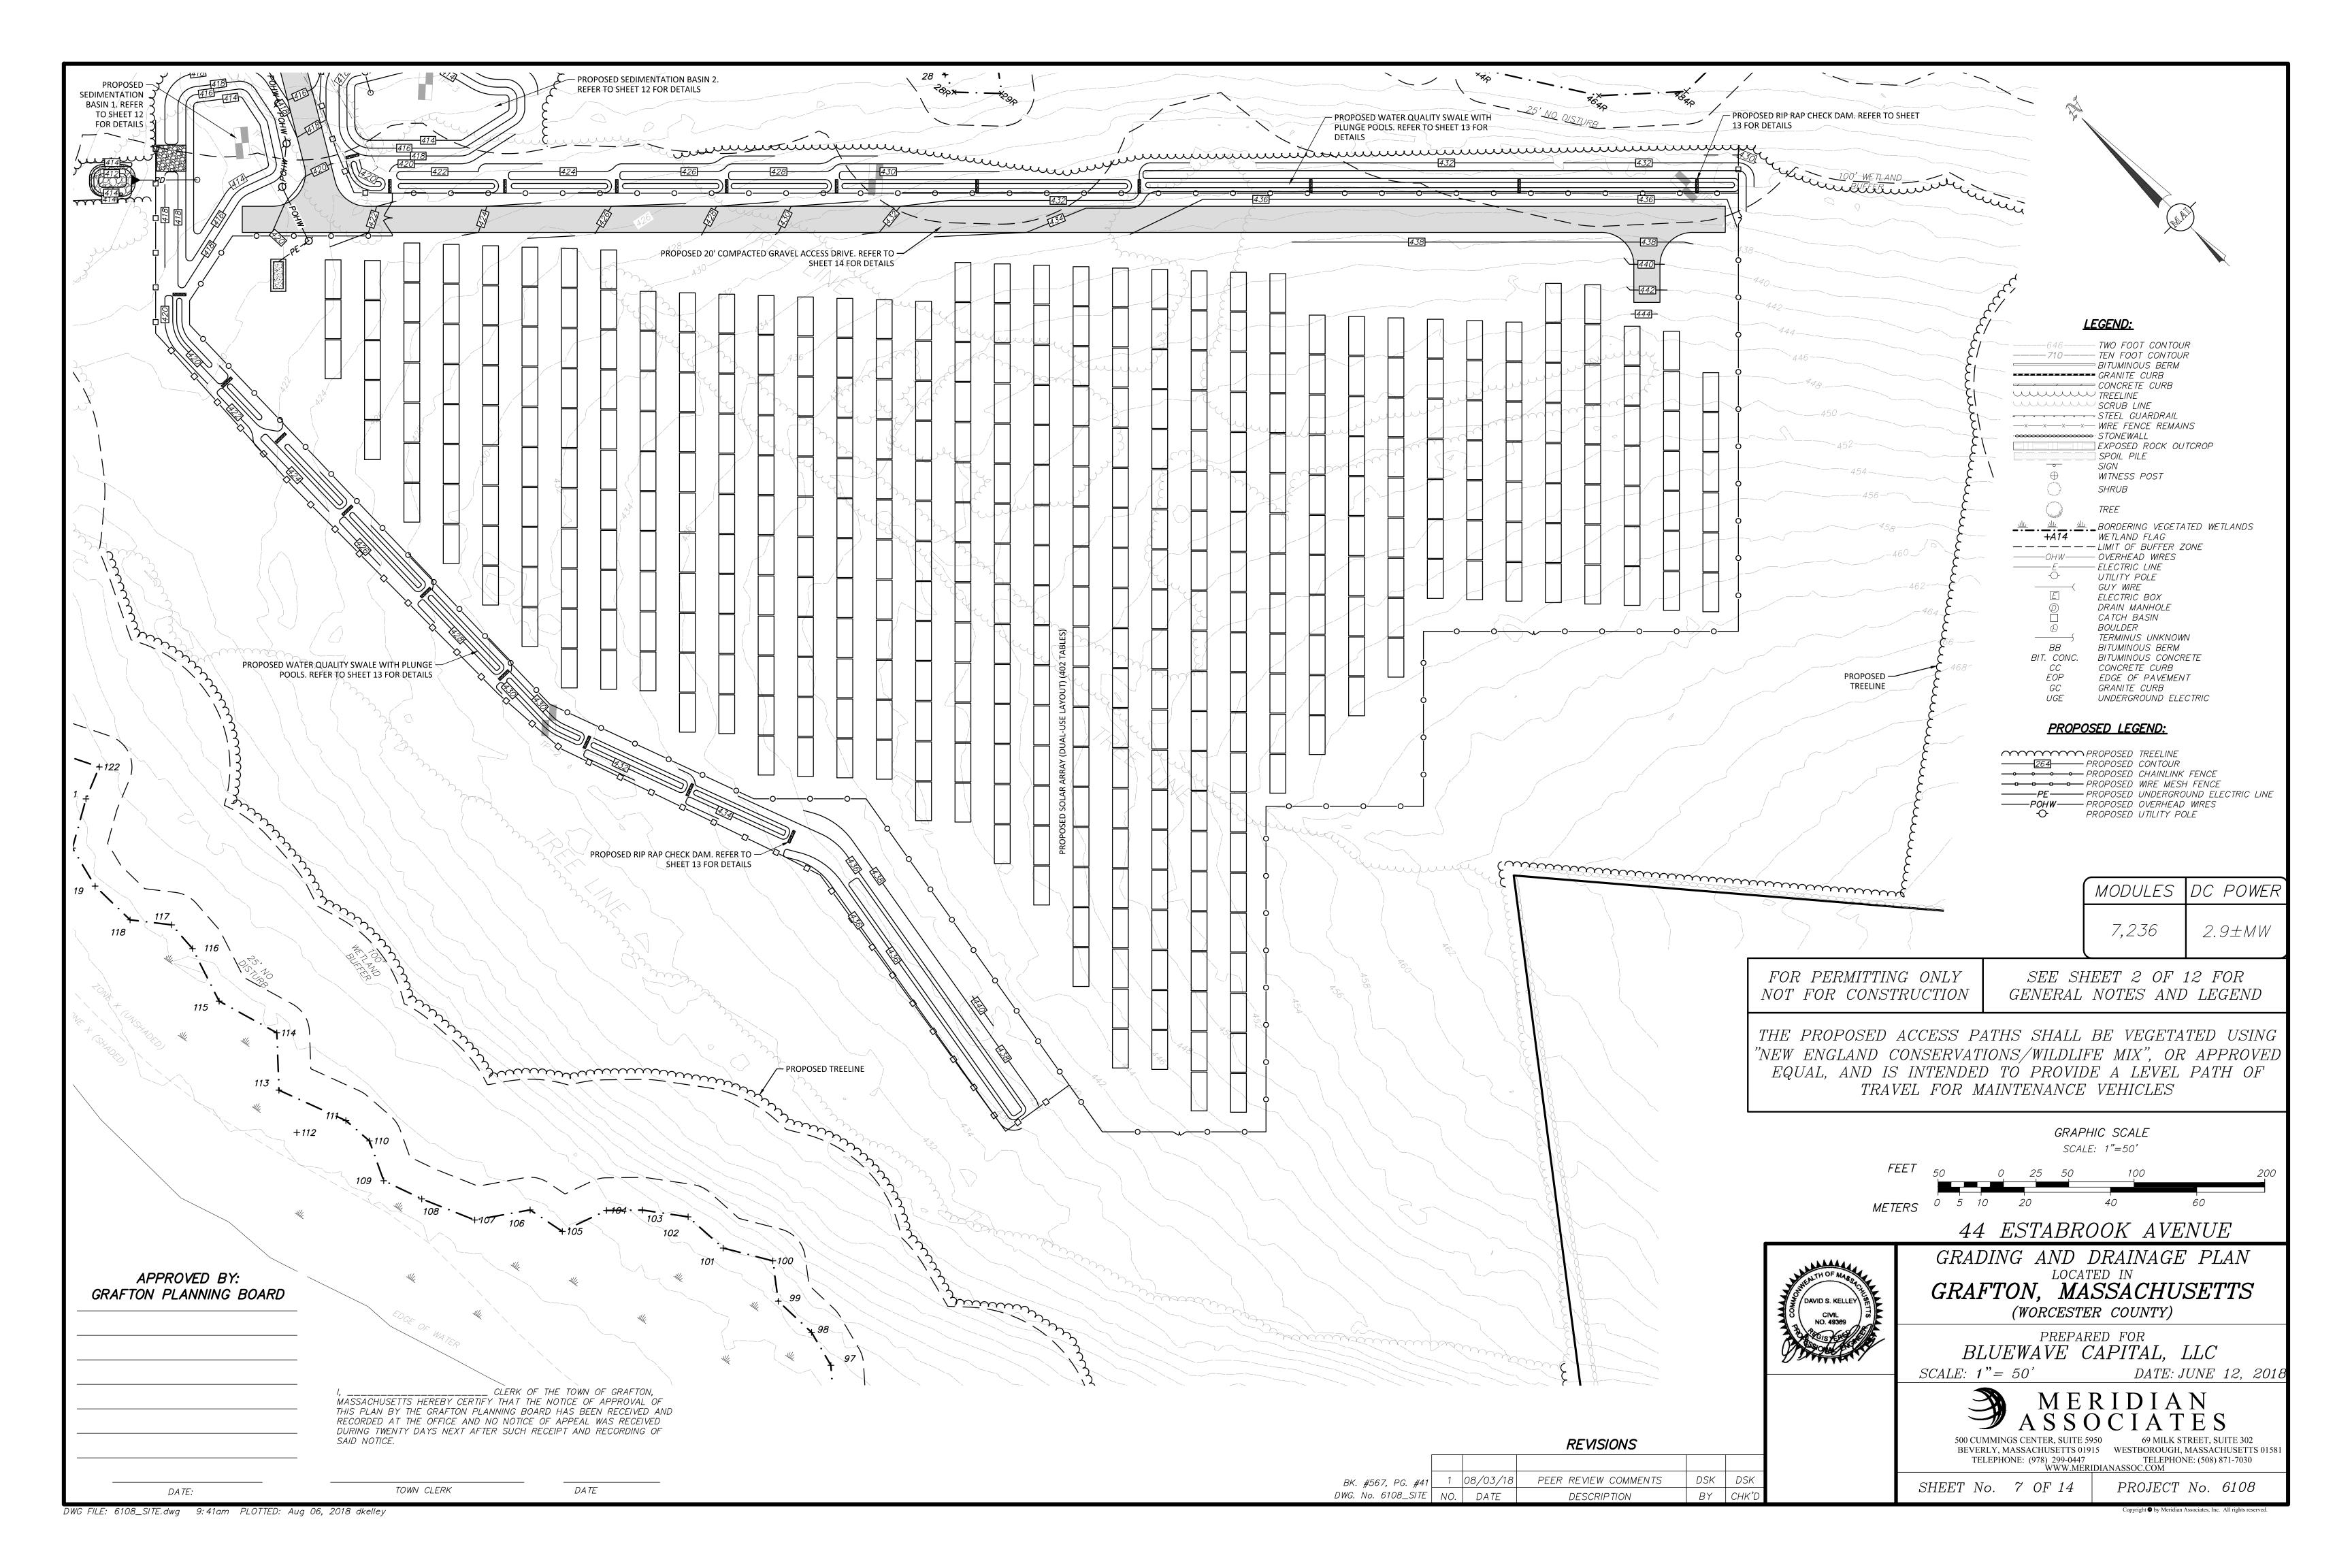

THE PROPOSED ACCESS PATHS SHALL BE VEGETATED USING

"NEW ENGLAND CONSERVATIONS/WILDLIFE MIX", OR APPROVED EQUAL, AND IS INTENDED TO PROVIDE A LEVEL PATH OF TRAVEL FOR MAINTENANCE VEHICLES

FOR PERMITTING ONLY NOT FOR CONSTRUCTION

SEE SHEET 2 OF 12 FOR GENERAL NOTES AND LEGEND

DC POWER MODULES 7,236  $2.9\pm MW$ 

# EROSION CONTROL LEGEND:

PROPOSED HAYBALES & SILT FENCE NEW ENGLAND *\CONSERVATION/WILDLIFE " MIX PLANTING AREA

RIPRAP AREA

-x-x-x-x-PROPOSED SILT FENCE PROPOSED FILTERMITT

# LEGEND:

----646---- TWO FOOT CONTOUR

-----710---- TEN FOOT CONTOUR → BITUMINOUS BERM GRANITE CURB CONCRETE CURB TREELINE SCRUB LINE ∞·STONEWALL EXPOSED ROCK OUTCROP SPOIL PILE WITNESS POST

SHRUB <u>₩</u> <u>₩</u> BORDERING VEGETATED WETLANDS +A14 WETLAND FLAG

----OHW-OVERHEAD WIRES UTILITY POLE GUY WIRE ELECTRIC BOX

DRAIN MANHOLE CATCH BASIN **BOULDER** TERMINUS UNKNOWN BITUMINOUS BERM BITUMINOUS CONCRETE

CONCRETE CURB EDGE OF PAVEMENT GRANITE CURB UNDERGROUND ELECTRIC


# PROPOSED LEGEND:

PROPOSED TREELINE ------PE-------PROPOSED UNDERGROUND ELECTRIC LINE -----POHW------PROPOSED OVERHEAD WIRES

PROPOSED UTILITY POLE

GRAPHIC SCALE SCALE: 1"=100' 0 50 100

44 ESTABROOK AVENUE

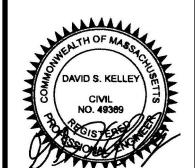

BK. #567, PG. #41 1 08/03/18

DWG. No. 6108_SITE | NO. | DATE

PEER REVIEW COMMENTS

DESCRIPTION

DSK DSK

BY CHK'L

LOCATED IN GRAFTON, MASSACHUSETTS

(WORCESTER COUNTY)

PREPARED FOR BLUEWAVE CAPITAL, LLC

SCALE: 1" = 100'DATE: JUNE 12, 2018




BEVERLY, MASSACHUSETTS 01915 WESTBOROUGH, MASSACHUSETTS 0158 TELEPHONE: (978) 299-0447 TELEPHONE: (508) 871-7030 WWW.MERIDIANASSOC.COM


SHEET No. 8 OF 14


PROJECT No. 6108

DATE

TOWN CLERK

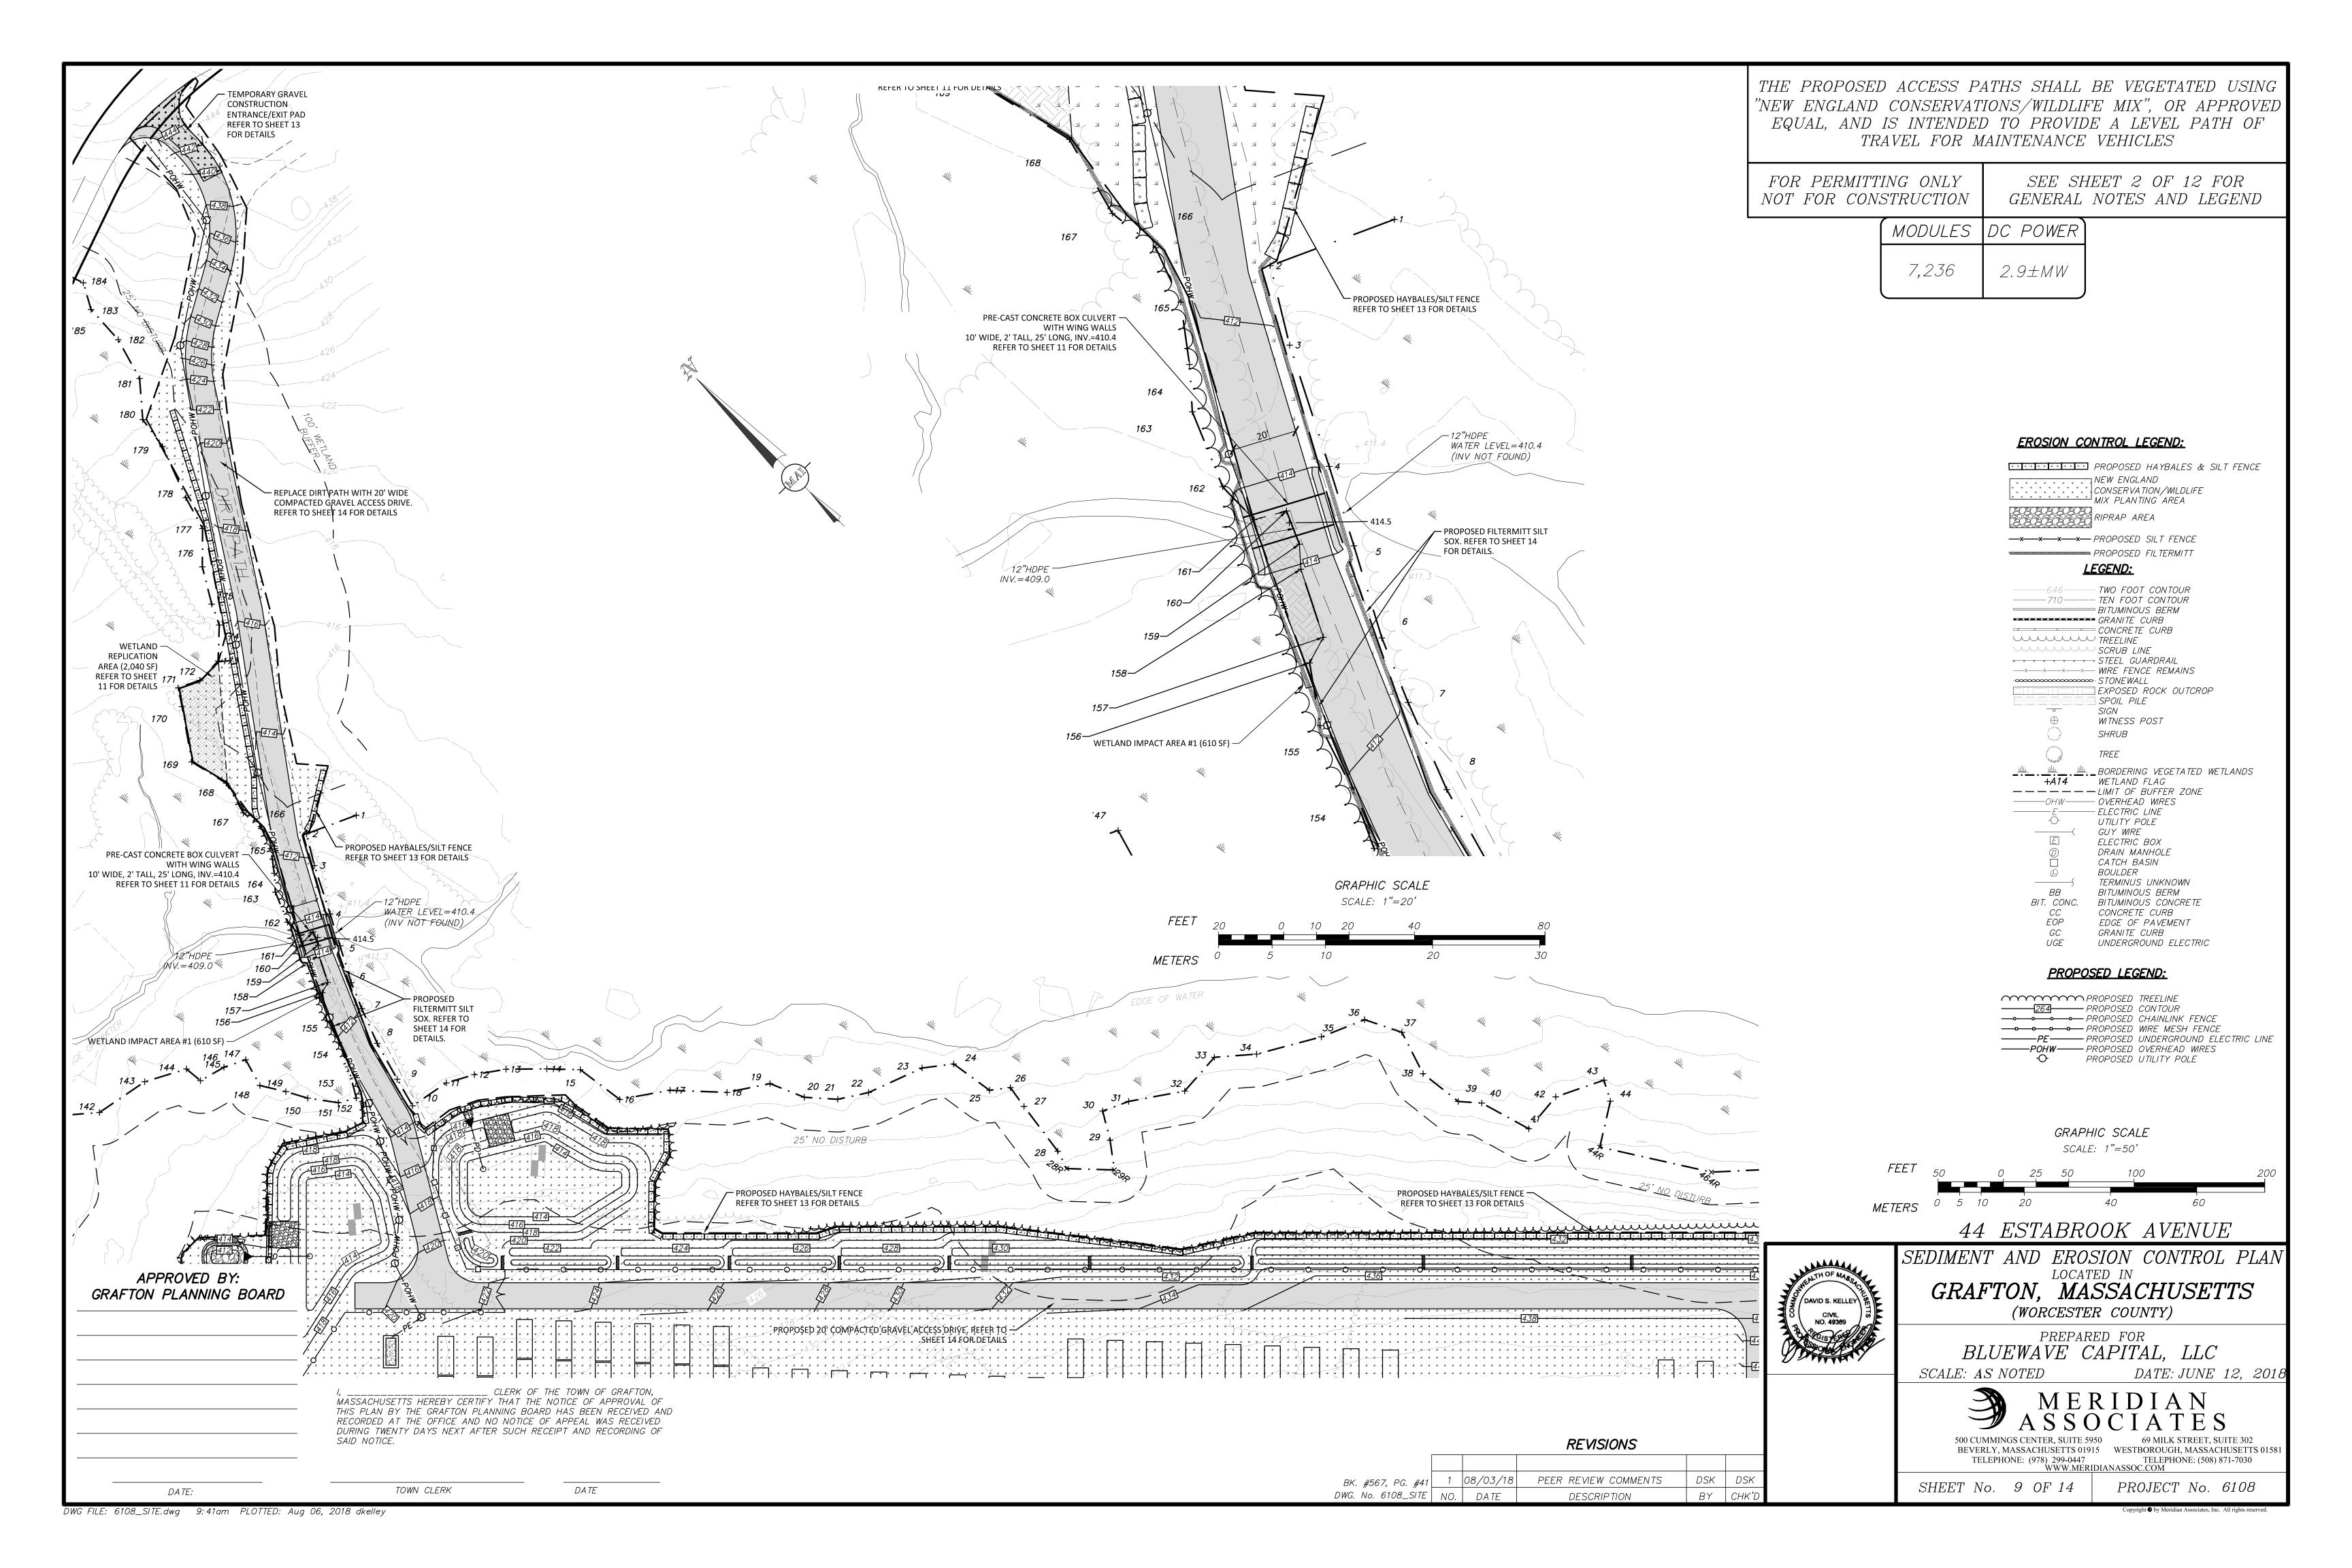

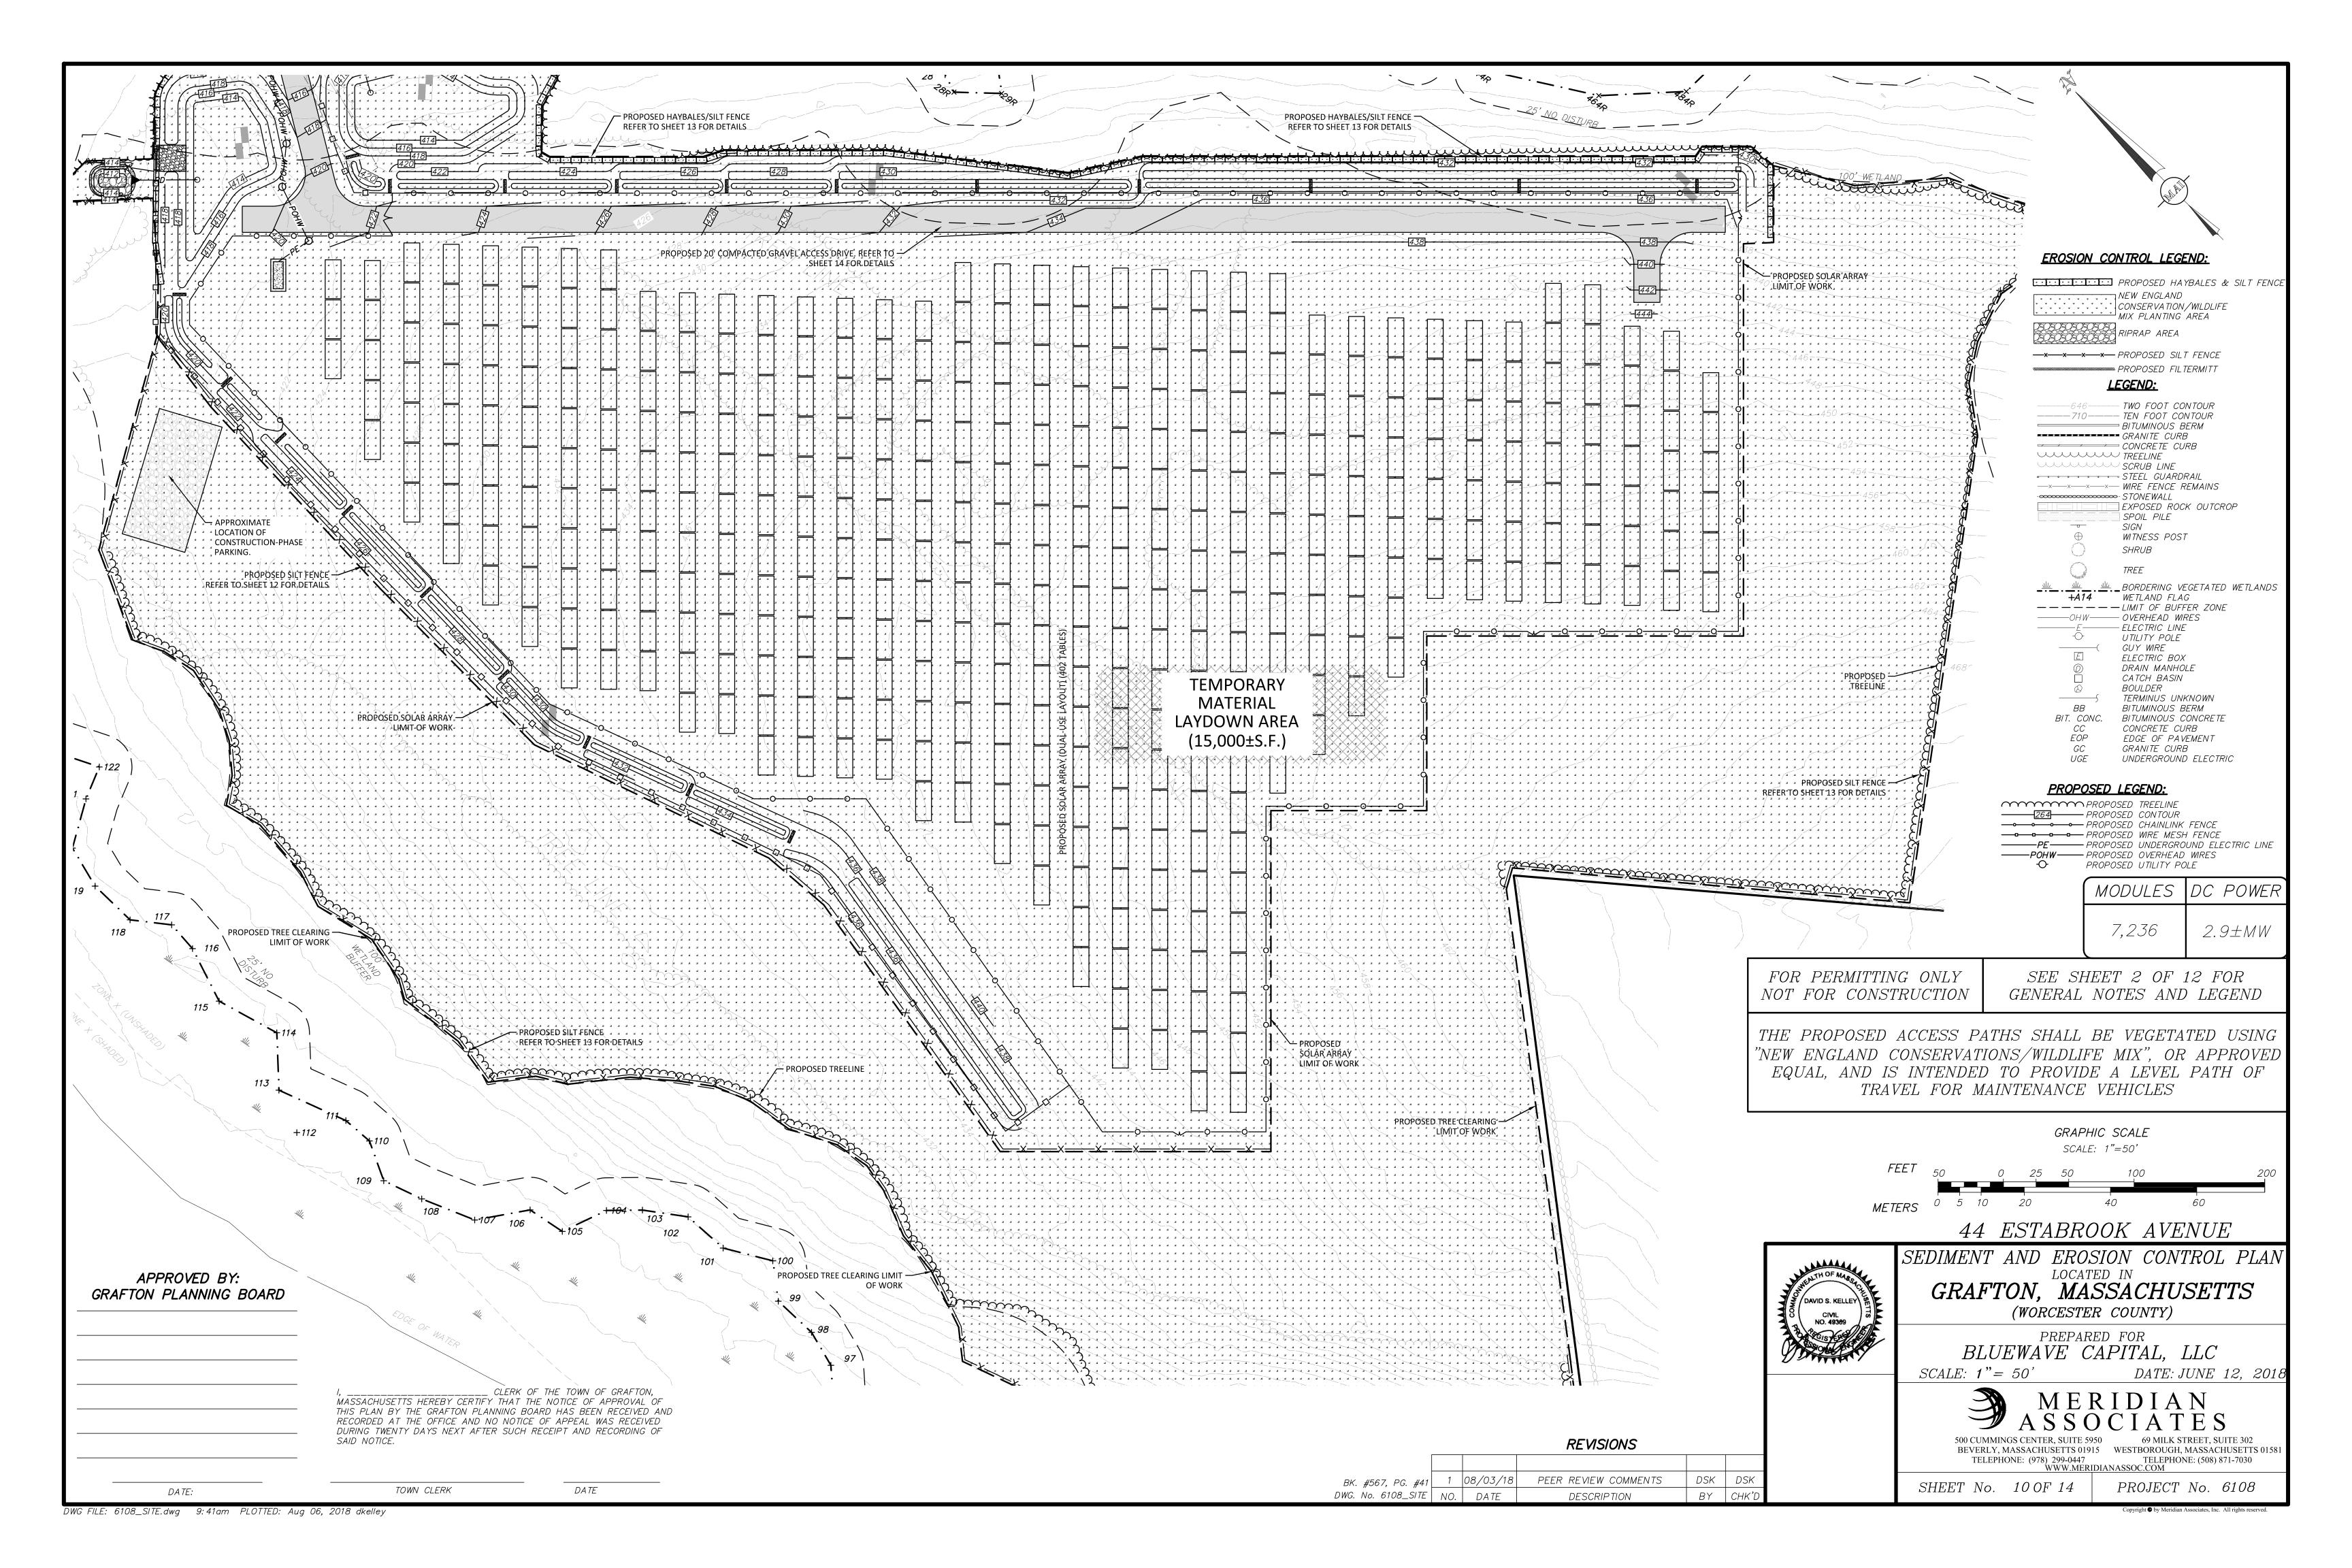


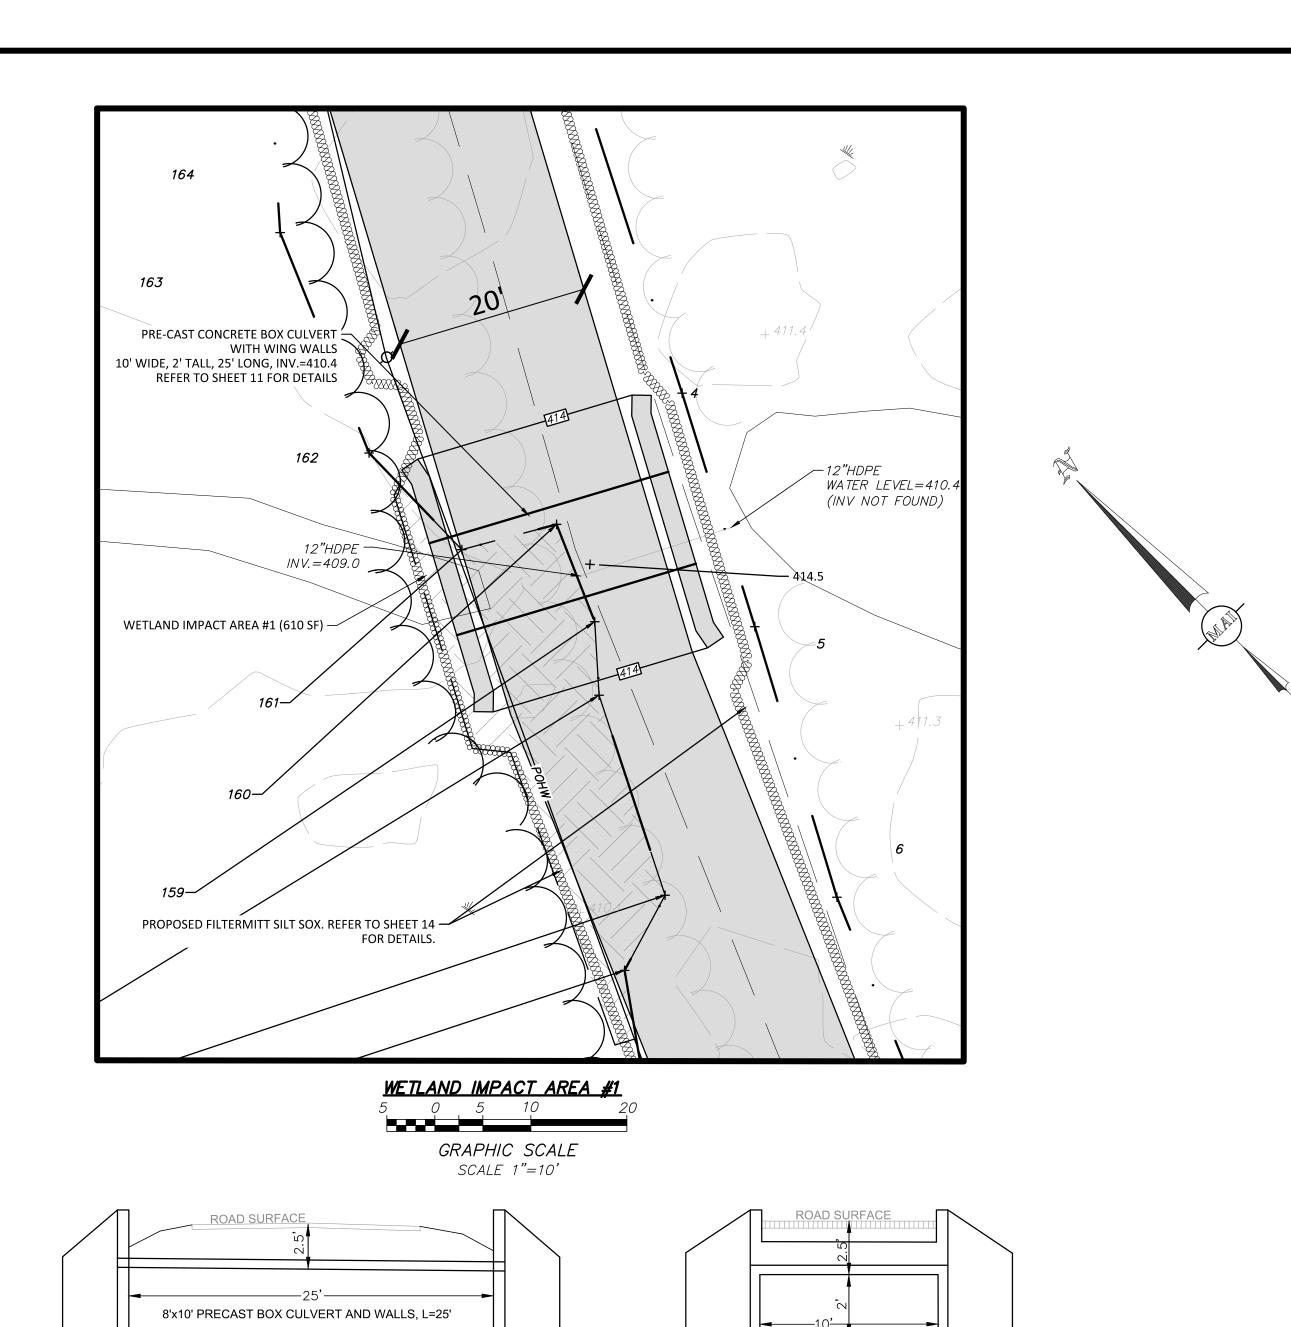

APPROX.-

END SECTION

STREAM BED

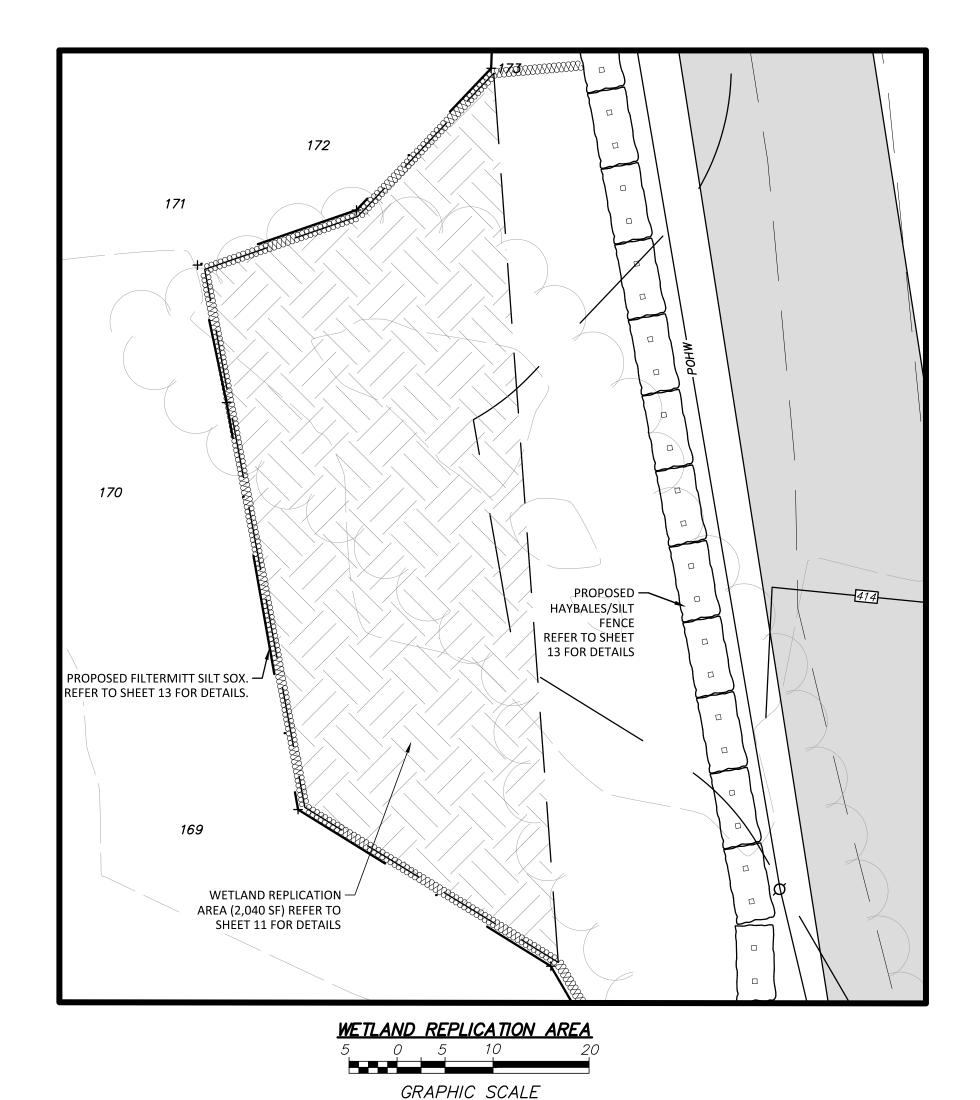

SCALE 1"=10'

### WETLAND REPLICATION AREA CONSTRUCTION SEQUENCE

- 1. A QUALIFIED WETLAND SCIENTIST SHALL SUPERVISE ALL ASPECTS OF THE PROPOSED WETLAND REPLICATION AREA DURING CONSTRUCTION; EG., EROSION CONTROLS, SITE PREPARATORY, GRADING, BACKFILLING, PLANTING AND SEEDING.
- 2.FLAG OR STAKE LIMITS OF WETLAND REPLICATION AREA. FLAG TREES AND/OR SHRUBS ADJACENT TO THE EXISTING WETLAND BOUNDARY TO REMAIN. INSTALL EROSION CONTROL BARRIER (I.E,. STRAW WATTLES) ALONG INTERSECTION OF THE WETLAND REPLICATION AREA AND ADJACENT WETLAND, TAKING INTO CONSIDERING THAT MINOR GRADING WITHIN THE WETLAND MAY BE REQUIRED TO ACHIEVE A SUITABLE HYDROLOGIC CONNECTION TO THE WRA. ONCE THE WETLAND REPLICATION AREA AND ADJACENT SIDE SLOPE HAVE BEEN GRADED, INSTALL AN EROSION CONTROL BARRIER (I.E., STRAW WATTLES) AT THE TOE OF SLOPE TO PROTECT THE WETLAND REPLICATION AREA.
- 3.DURING CONSTRUCTION OF THE WETLAND REPLICATION AREA, THE SUPERVISORY WETLAND SCIENTIST SHALL OVERSEE THE PROPOSED GRADING AND PLANTING SCHEME. THE FINAL ELEVATION SHALL BE DETERMINED IN THE FIELD AND WILL CORRESPOND TO THE ELEVATION OF THE ADJACENT WETLAND. DURING CONSTRUCTION, THE WETLAND REPLICATION AREA SHALL BE EXCAVATED TO FINAL GRADE UNLESS A SUITABLE TOPSOIL IS NOT ENCOUNTERED, AT WHICH TIME THE AREA WILL BE EXCAVATED TO ONE FOOT BELOW THE FINAL DESIGN GRADE TO FACILITATE THE PLACEMENT OF APPROVED CLEAN WETLAND SOIL (12% ORGANIC CARBON CONTENT (OR 20% ORGANIC MATTER CONTENT) AND PH OF 6.2-6.8) AS A SUITABLE SUBSTRATE FOR THE ESTABLISHMENT OF WETLAND VEGETATION. WETLAND SOILS WILL CONSIST OF THE TOPSOIL (A HORIZON) FROM THE WETLAND IMPACT AREA AND/OR A WETLAND SOIL MIXTURE MANUFACTURED BY COMBINING TOPSOIL WITH A SOIL TEXTURAL CLASS OF SANDY LOAM, FINE SANDY LOAM, OR SILT LOAM WITH DECOMPOSED LEAF LITTER AT A 1:1 RATIO. THE WETLAND SOIL SHALL BE FREE OF STUMPS, ROOTS, HEAVY OR STIFF CLAY, STONES, COARSE SAND, NOXIOUS WEEDS, WEED SEEDS OR OTHER LITTER. SETTLING OF SOILS SHALL BE TAKEN INTO CONSIDERATION FOR FINAL ELEVATIONS.
- 4. APPLY WETLAND SEED MIX (NEW ENGLAND WETLAND PLANTS, INC., NEW ENGLAND WETMIX, OR EQUIVALENT) AT A RATE OF 1 LB PER 2,500 SF OR HIGHER IF APPLIED AT THE END OF THE GROWING SEASON AND LIGHTLY RAKE TO INSURE SEED-TO-SOIL CONTACT. THERE SHALL BE NO SEEDING IN AREAS OF STANDING WATER.
- 5. APPLY CONSERVATION SEED MIX TO SIDE SLOPES AT A RATE OF 1 LB PER 1,750 SF AND LIGHTLY RAKE TO INSURE SEED-TO-SOIL CONTACT.
- 6. APPLY A LIGHT MULCH OF CLEAN WEED FREE STRAW.
- 7. THE SUPERVISORY WETLAND SCIENTIST SHALL RESERVE THE RIGHT, DEPENDING ON WEATHER CONDITIONS, TO REQUIRE SUPPLEMENTAL WATERING OF WETLAND PLANTINGS.
- 8. REMOVE EROSION CONTROL BARRIERS UPON STABILIZATION OF THE SIDE SLOPE AND WETLAND REPLICATION AREA.

# APPROVED BY: GRAFTON PLANNING BOARD

CLERK OF THE TOWN OF GRAFTON, MASSACHUSETTS HEREBY CERTIFY THAT THE NOTICE OF APPROVAL OF RECORDED AT THE OFFICE AND NO NOTICE OF APPEAL WAS RECEIVED DURING TWENTY DAYS NEXT AFTER SUCH RECEIPT AND RECORDING OF

TOWN CLERK

THIS PLAN BY THE GRAFTON PLANNING BOARD HAS BEEN RECEIVED AND

DATE

TOP OF FOOTING TO BE

EMBEDDED 2' MINIMUM

2.FINAL DESIGN OF PRECAST ARCH IS TO BE PROVIDED BY VENDOR AND APPROVED BY THE ENGINEER OF RECORD AND THE TOWN OF


GRAFTON BUILDING DEPARTMENT PRIOR TO INSTALLATION.

PRECAST BOX CULVERT DETAIL (N. T. S.)

1. THIS DETAIL IS PROVIDED FOR REFERENCE ONLY.

# REVISIONS

BK. #567, PG. #41 1 08/03/18 PEER REVIEW COMMENTS DSK DSK DWG. No. 6108_SITE | NO. | DATE DESCRIPTION BY CHK'D 44 ESTABROOK AVENUE

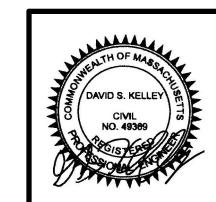

WETLAND CROSSING AND REPLICATION DETAILS LOCATED IN

GRAFTON, MASSACHUSETTS

(WORCESTER COUNTY) PREPARED FOR

BLUEWAVE CAPITAL, LLC SCALE: 1" = 10'DATE: JUNE 12, 2018

BEVERLY, MASSACHUSETTS 01915 WESTBOROUGH, MASSACHUSETTS 01581 TELEPHONE: (978) 299-0447 TELEPHONE: (508) 871-7030 WWW.MERIDIANASSOC.COM


SHEET No. 11 OF 14 PROJECT No. 6108

<u>PROFILE</u>

NOTES:

APPROX.

STREAM BED

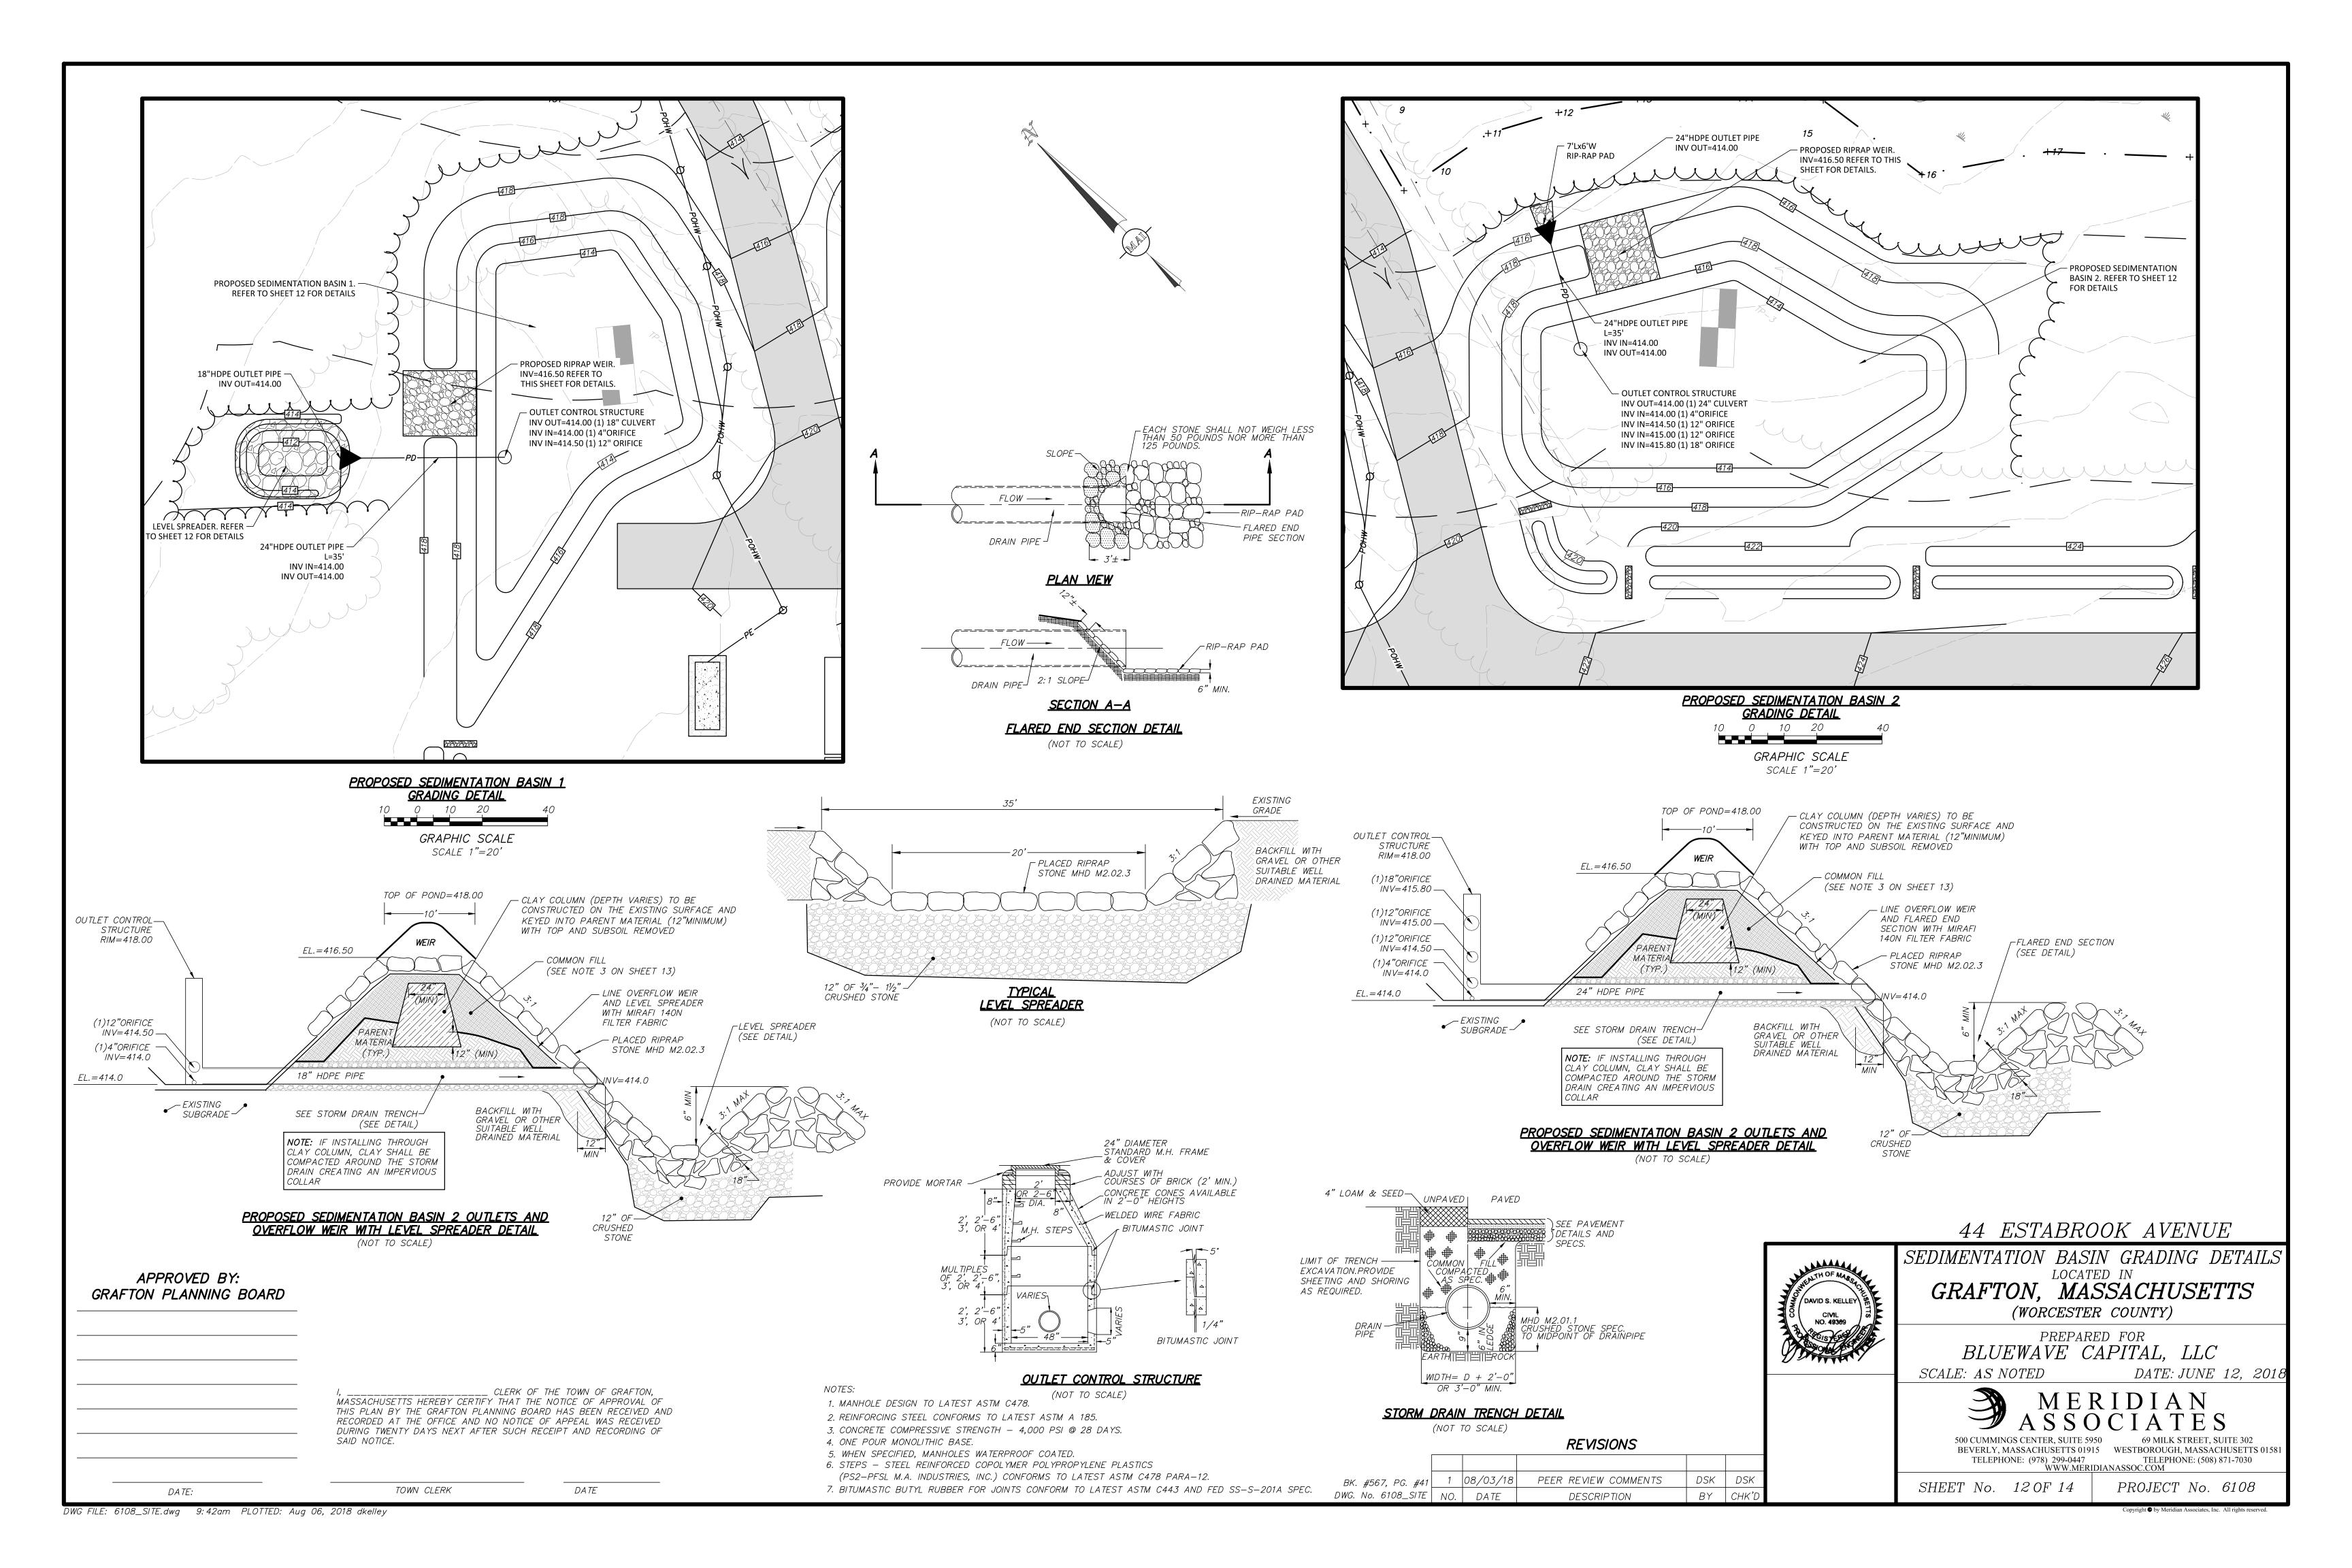

- 1. EXISTING GROUND WITHIN THE PROPOSED CHAINLINK FENCE SHALL BE CLEARED, STUMPED AND RE-GRADED TO ELIMINATE MINOR SURFACE DISTURBANCES. RE-VEGETATION OF THE SITE SHALL BE ESTABLISHED WITH LOW GROWTH GROUND COVER.
- 2. THE PROPOSED LIMIT OF WORK LINE ALSO DEPICTS THE EXTENT OF TREE CLEARING TO BE PERFORMED ON THE PROJECT SITE. NO TREES OUTSIDE THE DESIGNATED LIMIT OF WORK LINE ARE TO BE REMOVED BY THE CONTRACTOR.
- COMMON FILL (SITE GRADING AREAS) SHALL CONSIST OF MINERAL SOIL SUBSTANTIALLY FREE FROM ORGANIC MATERIALS, LOAM, WOOD TRASH AND OTHER OBJECTIONABLE MATERIALS WHICH MAY BE COMPRESSIBLE OR WHICH CANNOT BE PROPERLY COMPACTED. SELECT COMMON FILL SHALL NOT CONTAIN STONES LARGER THAN 2-IN. IN LARGEST DIAMETER AND SHALL HAVE A MAXIMUM OF 75% PASSING THE NO. 40 SIEVE AND A MAXIMUM OF 20% PASSING THE NO. 200 SIEVE. SELECT COMMON FILL SHALL NOT CONTAIN GRANITE BLOCKS, BROKEN CONCRETE, MASONRY RUBBLE OR OTHER SIMILAR MATERIALS. IT SHALL HAVE PHYSICAL PROPERTIES SUCH THAT IT CAN BE READILY SPREAD AND COMPACTED DURING FILLING. SNOW, ICE AND FROZEN SOIL WILL NOT BE PERMITTED. SOIL EXCAVATED FROM THE STRUCTURE AREAS AND WHICH MEETS THE ABOVE REQUIREMENTS MAY BE USED.
- ORDINARY FILL SHALL BE WELL GRADED, NATURAL INORGANIC SOIL, FREE OF ORGANIC OR OTHER WEAK OR COMPRESSIBLE MATERIALS, FROZEN MATERIALS, AND OF STONES LARGER THAN TWO THIRDS (3/3) THE LIFT THICKNESS. IT SHALL BE OF SUCH NATURE AND CHARACTER THAT IT CAN BE COMPACTED TO THE SPECIFIED DENSITIES IN A REASONABLE LENGTH OF TIME. IT SHALL BE FREE OF PLASTIC CLAY, OF ALL MATERIALS SUBJECT TO DECAY, DECOMPOSITION, OR DISSOLUTION, AND OF CINDERS OR OTHER MATERIALS THAT WILL CORRODE PIPING OR OTHER METAL. IT SHALL HAVE A MINIMUM DRY DENSITY OF NOT LESS THAN 120 POUNDS PER CUBIC FOOT. MATERIAL FROM EXCAVATION ON THE SITE MAY BE USED AS ORDINARY FILL IF IT MEETS THE ABOVE REQUIREMENTS. ORDINARY FILL SHALL HAVE A MAXIMUM OF 60% PASSING THE #40 SIEVE, AND A MAXIMUM OF 20% PASSING THE #200 SIEVE. IT SHOULD NOT CONTAIN BROKEN CONCRETE, MASONRY RUBBLE OR OTHER SIMILAR MATERIALS, AND SHALL HAVE PHYSICAL PROPERTIES SUCH THAT IT CAN BE READILY SPREAD AND COMPACTED DURING FILLING. SNOW, ICE AND FROZEN SOIL SHALL NOT BE PERMITTED.
- SELECT COMMON FILL (ROADWAY AREAS) SHALL BE PLACED IN LAYERS HAVING A MAXIMUM THICKNESS OF 8 IN. MEASURED BEFORE COMPACTION. EACH LAYER OF FILL SHALL BE COMPACTED TO AT LEAST 95 PERCENT OF MAXIMUM DRY DENSITY DETERMINED BY THE ASTM D1557. COMPACTION OF STRUCTURAL FILL SHALL CONSIST OF FULLY LOADED TEN WHEEL TRUCKS. A TRACTOR DOZER WEIGHING AT LEAST 30.000 LBS AND OPERATED AT FULL SPEED, A HEAVY VIBRATORY ROLLER, OR OTHER METHOD ONLY AS APPROVED BY THE ENGINEER. COMPACTION OF SELECT COMMON FILL IN CONFINED AREAS ADJACENT TO STRUCTURES SHALL BE ACCOMPLISHED BY HAND OPERATED VIBRATORY EQUIPMENT OR MECHANICAL TAMPERS APPROVED BY THE ENGINEER. AS A MINIMUM, COMPACTION OF SELECT COMMON FILL SHALL CONSIST OF FOUR COVERAGES OF THE APPROVED EQUIPMENT.
- 6. SITE PREPARATION SHALL INCLUDE CLEARING, GRUBBING, DELETERIOUS SOILS, VEGETATION AND DEBRIS. ALL TREES, STUMPS, BRUSH, SHRUBS, ROOTS, GRASS, WEEDS, RUBBISH, STONES LARGER THAN 2-IN. IN THE LARGEST DIAMETER AND OTHER OBJECTIONABLE MATERIAL SHALL BE REMOVED AND DISPOSED OF FROM AREAS TO BE FILLED AND COMPACTED. AREAS OUTSIDE OF THE LIMITS OF WORK SHALL BE PROTECTED FROM DAMAGE AND NO EQUIPMENT OR MATERIALS SHALL BE STORED IN THESE AREAS. NO STUMPS, TREES, LIMBS, OR BRUSH SHALL BE BURIED IN ANY FILLS OR EMBANKMENTS.
- EROSION AND SEDIMENT CONTROL, BOTH DURING AND AFTER CONSTRUCTION, SHALL BE PROVIDED AS REQUIRED TO RETAIN SEDIMENT ONSITE, AND TO CONTROL EROSION OF EMBANKMENTS, TEMPORARY AND FINAL EXPOSED SLOPES, AND TEMPORARY MATERIAL STOCKPILE(S). SILT FENCES, CHECK DAMS, DRAINAGE DITCHES OR SWALES, TEMPORARY SEEDING, AND PRE-MANUFACTURED TEXTILES, GEOTUBES, GEOGRID, CELLULAR GEOWEB, ETC., SHALL BE UTILIZED AS APPROPRIATE. EROSION AND SETTLEMENT CONTROL MEASURES SHALL BE IN ACCORDANCE WITH ALL PERMITS AND CODES AND THIS SPECIFICATION. DURING THE EXCAVATION OF THE WORK AT THE SITE, OPERATIONS SHALL BE CONTINUOUSLY MONITORED TO AVOID THE CREATION OF CONDITIONS THAT COULD LEAD TO EXCESSIVE EROSION OF SOIL WITH SURFACE RUNOFF FROM THE WORK AREAS. CONTROLS SHALL BE PROVIDED TO PROTECT THE WATER QUALITY AND SHALL BE IN ACCORDANCE WITH PROJECT DOCUMENTS AND ALL LOCAL, STATE AND FEDERAL LAWS AND REGULATIONS. EROSION CONTROL MEASURES SHALL BE EMPLOYED TO REDUCE EROSION OF SLOPES AND SILTATION OF OFF-SITE OUTFALLS AND TRIBUTARIES.
- 8. UPON SIGNS OF CONCENTRATED FLOW BY EVIDENCE OF GULLYING OR RILLING IN DISTURBED AREAS, HAYBALES SHALL BE PLACED IN THESE AREAS, SPACED EVERY 50' IN THE UPGRADIENT SLOPE.
- 9. ALL DISTURBED AREAS SHALL BE RE-ESTABLISHED WITH "NEW ENGLAND CONSERVATION/WILDLIFE MIX" OR APPROVED EQUAL.

### ESTABLISHED GUIDELINES FOR NEW <u>ENGLAND CONSERVATION/WILDLIFE MIX</u>

THE MIX PROVIDES A PERMANENT COVER OF GRASSES, WILDFLOWERS AND LEGUMES TO PROVIDE BOTH GOOD EROSION CONTROL AND WILDLIFE HABITAT VALUE. THIS MIX IS DESIGNED TO BE A NO MAINTENANCE SEEDING, AND IT IS APPROPRIATE TO CUT AND FILL SLOPES, DETENTION BASIN SLOPES, AND DISTURBED AREAS ADJACENT TO COMMERCIAL AND RÉSIDENTIAL PROJECTS. ALWAYS APPLY ON CLEAN BARE SOIL. THE MIX MAY BE APPLIED BY HYDRO-SEEDING, BY MECHANICAL SPREADER, OR ON SMALL SITES IT CAN BE SPREAD BY HAND. LIGHTLY RAKE, OR ROLL TO ENSURE PROPER SEED TO SOIL CONTACT. BEST RESULTS ARE OBTAINED WITH A SPRING SEEDING. LATE SPRING THROUGH EARLY SUMMER SEEDING WILL BENEFIT WITH A LIGHT MULCHING OF WEED-FREE STRAW TO CONSERVE MOISTURE. IF CONDITIONS ARE DRIER THAN USUAL, WATERING WILL BE

REQUIRED. LATE FALL AND WINTER DORMANT SEEDING REQUIRE AN INCREASE IN THE SEEDING RATE. FERTILIZATION IS NOT REQUIRED UNLESS THE SOILS ARE PARTICULARLY INFERTILE. PREPARATION OF A CLEAN WEED FREE SOIL SURFACE IS NECESSARY FOR OPTIMAL RESULTS.

- ELYMUS VIRGINICUS
- SCHIZACHYRIUM SCOPARIUM FESTUCA RUBRA
- ANDROPOGON GERARDII
- CHAMAECRISTA FASCICULATA PANICUM CLANDESTINUM
- PANICUM VIRGATUM SORGHASTRUM NUTANS
- HELENIUM AUTUMNALE HELIOPSIS HELIANTHOIDES VERBENA HASTATA
- ASCLEPIAS SYRIACA ASTER UMBELLATUS
- EUPATORIUM PURPUREUM
- SOLIDAGO JUNCEA ZIZIA AUREA

# SEED BED PREPARATION:

REMOVE ALL INVASIVE SPECIES, TILL EXISTING SOIL AND RAKE SMOOTH. APPLY 3" OF COMPOSTED LEAF LITTER. ALL AREAS WHERE ROOTS HAVE BEEN GRUBBED SHALL BE

# SEED APPLICATION AND RATE:

THE IDEAL PLANTING DEPTH IS 1/4-1/2". UNDER IDEAL CONDITIONS SEEDS LAYING ON THE SURFACE WILL GERMINATE. RECOMMENDED APPLICATION RATE FOR SEEDING IS 1 LBS PER 1,750 SQUARE FEET.


FOR FALL INSTALLATION, SEED BETWEEN AUGUST 15 AND SEPTEMBER 10. FOR SPRING INSTALLATION, SEED AS EARLY AS POSSIBLE SOMETIME BETWEEN APRIL 15 AND MAY 10.

### FERTILIZATION AND SOIL REQUIREMENTS: REFER TO MANUFACTURERS RECOMMENDATIONS

GENERAL MAINTENANCE: REFER TO MANUFACTURERS RECOMMENDATIONS


REFER TO MANUFACTURERS RECOMMENDATIONS

FOR PERMITTING ONLY NOT FOR CONSTRUCTION

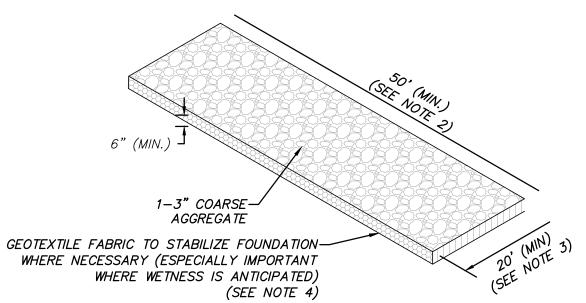

- 1. THE SOLE PURPOSE OF THIS DETAIL IS TO PROVIDE A STABLE ENTRANCE AND EXIT FROM A CONSTRUCTION SITE OR WETLAND CROSSING AND KEEP MUD AND SEDIMENT OFF PUBLIC ROADS AND WETLANDS IN ACCORDANCE WITH THE RECOMMENDATIONS STATED IN THE "MASSACHUSETTS EROSION AND SEDIMENT CONTROL GUIDELINES FOR URBAN AND SUBURBAN AREAS" AS PREPARED BY THE MASSACHUSETTS DEPARTMENT OF ENVIRONMENTAL PROTECTION.
- 2. EXTEND PAD BEYOND 50 FEET FOR HEAVY CONSTRUCTION TRAFFIC AS NECESSARY. LONGER ENTRANCES WILL PROVIDE BETTER CLEANING ACTION.
- 3. THE PAD SHALL EXTEND THE FULL WIDTH OF THE CONSTRUCTION ACCESS DRIVE.
- 4. WHERE NECESSARY, GEOTEXTILE FILTER FABRIC SHALL BE PLACED BETWEEN THE STONE FILL AND THE EARTH SURFACE BELOW THE PAD TO REDUCE THE MIGRATION OF SOIL PARTICLES FOR UNDERLYING SOIL INTO THE STONE AND VICE VERSA.

### TEMPORARY GRAVEL CONSTRUCTION TRACKING PAD (NOT TO SCALE)

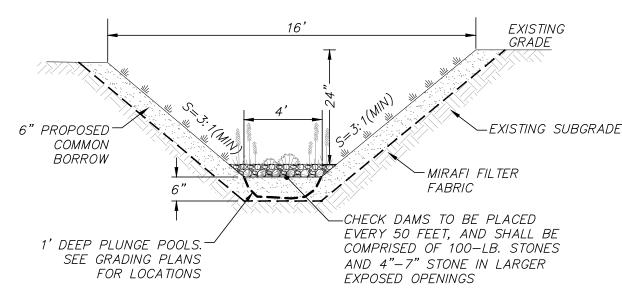


## WATER QUALITY SWALE


(NOT TO SCALE)

1. THE PLANTING PLAN WITHIN THE SWALES SHOULD INCLUDE A MIX OF HERBACEOUS PERENNIALS, SHRUBS, AND UNDERSTORY TREES THAT CAN TOLERATE INTERMITTENT PONDING, AND EXTENDED DRY PERIODS.


2. WATER QUALITY SWALES ARE TO BE SURROUNDED BY THREE (3) FOOT TALL WIRE MESH FENCING.

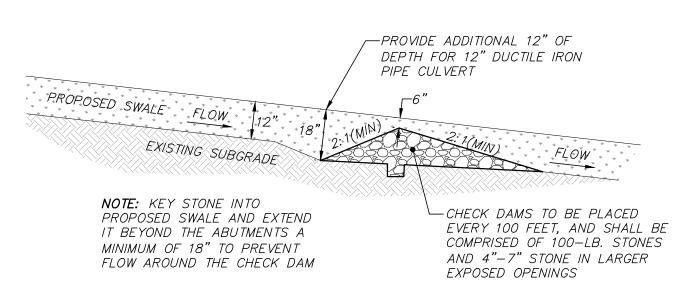

### TYPICAL STONE CHECK DAM (NOT TO SCALE)

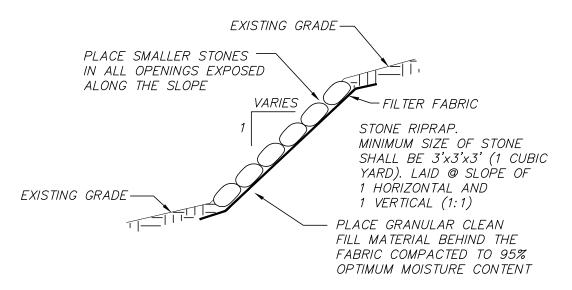

STONE RIPRAP SLOPE PROTECTION (NOT TO SCALE)

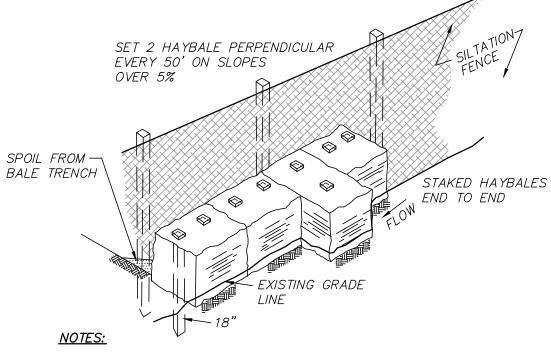

1. BALES TO BE TIED WITH ORGANIC FIBER TWINE ONLY NO PLASTIC OR WIRE.

2 HAYBALES TO BE SECURED WITH A MINIMUM OF TWO (2) 1" x 1" WOODEN STAKES PER BALE DRIVEN 18" MIN. INTO

# HAYBALE WITH SILT FENCE BARRIER

(NOT TO SCALE)

### REVISIONS 1 |08/03/18| PEER REVIEW COMMENTS DSK DSK DWG. No. 6108_DET | NO. | DATE DESCRIPTION BY CHK'C

Proud Member and Participant of

443 Bricker Road Bernville, PA 19506

**1.800.582.4005** +1.610.488.8496 Fax +1.610.488.8494

**ECSC-2™** Double Net Straw/Coconut Rolled Erosion Control Product

The ECSC-2™ is made with uniformly distributed 70% agricultural straw, 30% coconut fiber and two polypropylene nets securely sewn together with degradable

The ECSC-2™ has functional longevity of approximately 24 months, but will vary depending on soil and climatic conditions, and is suitable for slopes 2:1 to 1:1 and

low to medium flow channels. The ECSC-2™ meets Type 3.B specification requirements established by the Erosion Control Technology Council (ECTC) and Federal

30% Coconut

Color

White

"A" Size

3.75 ft 1.1 m

240 ft 73.2 m

57 lbs 25.9 kg

100 yd² 83.6 m²

ECTC Method 2 Rainfall

Unvegetated Shear Stress

Unvegetated Velocity

Vegetated Shear Stress

Vegetated Velocity

thread. The tightly compressed blankets are wrapped and include a product label, code and installation guide. The blankets are palletized for easy transportation.

www.eastcoasterosion.com

Highway Administration's (FHWA) FP-03 Section 713.17.

Weight <u>+</u>10%:

Mass/Unit Area

Elongation-MD

Elongation-TD

Light Penetration

Water Absorption

C-Factors

Slope Length (L)

< 50 ft (15 m)

50 ft - 100 ft

>100 ft (30 m)

Tensile Strength-MD

Tensile Strength-TD

Density / Specific Gravity ASTM D792

*May differ depending upon raw material variations

Thickness

#/Pallet

70% Straw

0.5" x 0.5"

Degradable Thread

7.5 ft 2.3 m

120 ft 36.6 m

57 lbs 25.9 kg

100 yd² 83.6 m²

ASTM D6475

ASTM D6525

ASTM D6818

ASTM D6818

**ASTM D6818** 

**ASTM D6567** 

**ASTM D1117** 

≤ 3:1

0.017

0.031

0.080

Test Method

ASTM D6459

Large-Scale Results obtained by 3rd Party GAI Accredited Independent Laboratory

**ASTM D6818** 

9.00 oz/yd² 305.1 g/m2

7.62 mm

2.60 kN/m

2.16 kN/m

≥ 2:1

0.080

0.125

0.170

EROSION CONTROL BLANKET. OR APPROVED EQUAL

AMOCO, 2130 SILT

STOP (OR EQUAL),

FLOW -

(WORK AREA)

3.5' WIDE

6"x6" TRENCH

WITH BACKFILL

IN PLACE

(NOT TO SCALE)

0.30 in

31 %

22.4 %

13 %

N/A %

436 %

3:1-2:1

0.028

0.059

0.090

148 lb/ft

178 lb/ft

Top: Medium weight UV Stabilized Polypropylene

Bottom: Lightweight Photodegradable Polypropylene

# GENERAL SEQUENCE OF CONSTRUCTION:

CONTACT DIGSAFE (888.344.7233) AND OBTAIN CLEARANCE AT LEAST 72 HOURS BEFORE INITIATING ANY EXCAVATION.

<u>SITE PREPARATION SHALL BE CONDUCTED IN TWO (2) PHASES</u> IN ORDER TO MAXIMIZE EROSION AND SEDIMENTATION CONTROL

IECA MOLOGY CO

Green

0.75" x 0.75"

Mega

15 ft 4.6 m

120 ft 36.6 m

114 lbs 51.7 kg

200 yd² 167.2 m²

50mm (2in) / hr-30 min SLR**=8.52

100mm (4in) / hr-30 min SLR**=11.01

150mm (6in) / hr-30 min St R**=14.28

ASTM D 6460 2.25 lbs/ft² 107.73 Pa

ASTM D 6460 8.0 ft/s 2.44 m/s

N/A lbs/ft² N/A Pa

N/A ft/s N/A m/s

ECTC Method 3 Shear Resistance Shear at .50 in soil loss 2.16 lb/ft²

**Soil Loss Ratio=Soil Loss Bare Soil/Soil Loss with RECP=1/C-Factor

*Bench scale tests should not be used for design purposes.

the product, material or device by AASHTO

Manning's N (Value Represents a Range)

- AMOCO, 2130

(OR EQUAL)

WOOD STAKES

7.7' O.C.

(WORK AREA)

PLAN VIEW

CROSS SECTION

<u>SILT FENCE</u>

ECTC Method 4 Germination Top soil; Fescue; 21 day incubation 503 %

***The preceding test data excerpts were reproduced with the permission

of AASHTO, however, this does not constitute endorsement or approval of

*Large-Scale Results obtained by 3rd Party GAI Accredited Independent

- ESTABLISH PHASE 1 EROSION AND SEDIMENTATION CONTROL MEASURES (HAYBALES & SILT FENCE) AS DEPICTED HEREIN AND AROUND AREAS OF DISTURBANCE AND MAINTAIN THROUGHOUT CONSTRUCTION IN ACCORDANCE WITH LOCAL REQUIREMENTS. PERFORM INSPECTIONS, REPAIR IF NECESSARY, AND DOCUMENT AFTER EACH PRECIPITATION EVENT OF 0.25-INCHES OR GREATER.
- PRIOR TO CONSTRUCTION, THE CONTRACTOR SHALL CONSTRUCT THE TEMPORARY GRAVEL CONSTRUCTION ENTRANCE/EXIT PAD AT ESTABROOK AVENUE. THE PAD SHALL CONSIST OF 1"-3" COARSE AGGREGATE WITH MINIMUM DIMENSIONS OF 50' (LENGTH) x 20' (WIDTH) x 6" (DEPTH) AND SET ON GEOTEXTILE FABRIC TO STABILIZE FOUNDATION (ESPECIALLY IMPORTANT WHERE WETNESS IS ANTICIPATED).
- PERFORM LIMITED CLEARING ACTIVITIES IN ORDER TO CONSTRUCT GRAVEL ACCESS DRIVE AND TURNAROUND.
- SITE PREPARATION SHALL INCLUDE CLEARING AND REMOVAL OF EXISTING VEGETATION AND DEBRIS. ALL TREES, STUMPS, BRUSH, SHRUBS, ROOTS, GRASS, WEEDS, RUBBISH, BITUMINOUS PAVEMENT, STONES LARGER THAN 2-IN. IN THE LARGEST DIAMETER AND OTHER OBJECTIONABLE MATERIAL SHALL BE REMOVED AND DISPOSED OF FROM AREAS TO BE FILLED AND COMPACTED. AREAS OUTSIDE OF THE LIMITS OF WORK SHALL BE PROTECTED FROM DAMAGE. NO STUMPS, TREES, LIMBS, OR BRUSH SHALL BE BURIED IN ANY FILLS OR EMBANKMENTS.
- 6. CONSTRUCT SEDIMENTATION BASINS (SHOWN ON PLANS).
- GRUBBING OF AREAS WITHIN THE PROPOSED FENCE AND GRADING AREAS ONLY SHALL BE CONDUCTED AFTER THE INSTALLATION OF THE SEDIMENTATION BASIN.
- 8. FOR AREAS WHERE NO GRADING IS PROPOSED, REPAIR UNEVEN AREAS WITHIN LIMITS OF THE SOLAR DEVELOPMENT, AS NECESSARY TO CREATE A TOLERABLE GROUND SURFACE. GENERAL TOLERANCE FOR ALLOWABLE GROUND SLOPE IS TWO FOOT VERTICAL CHANGE OVER A 20 FOOT HORIZONTAL RUN [NOTE THAT THIS REFERS TO THE ALLOWABLE LONGITUDINAL SLOPE (I.E., ALONG THE CONTOUR) AND NOT THE INCLINATION OF THE EXPOSURE (I.E., PERPENDICULAR TO THE CONTOUR)].
- UPON SIGNS OF CONCENTRATED FLOW BY EVIDENCE OF GULLYING OR RILLING IN DISTURBED AREAS, HAYBALES, OR APPROVED EQUAL, SHALL BE PLACED IN THESE AREAS, SPACED EVERY 50' IN THE UPGRADIENT SLOPE.


### <u>PHASE II:</u>

10. ESTABLISH PHASE II EROSION AND SEDIMENTATION CONTROL MEASURES (HAYBALES & SILT FENCE) AS DEPICTED HEREIN AND AROUND AREAS OF DISTURBANCE AND MAINTAIN THROUGHOUT CONSTRUCTION IN ACCORDANCE WITH LOCAL REQUIREMENTS. PERFORM INSPECTIONS, REPAIR IF NECESSARY, AND DOCUMENT AFTER EACH PRECIPITATION EVENT OF 0.25-INCHES OR GREATER (PHASE I EROSION CONTROL IS TO REMAIN IN PLACE AND MAINTAINED AS DESCRIBED ABOVE).

### REPEAT STEPS 5, 6, 7, 8 AND 9 ABOVE FOR PHASE II.

- . RECEIVE AND STAGE MATERIALS. RE-LOCATE COMPONENTS (E.G., CONDUIT, WIRING AND POSTS) TO SOLAR DEVELOPMENT AREA AS THEY ARE REQUIRED.
- 12. INSTALL RACKING SYSTEM, MOUNT THE PV PANELS ON FRAME AT THE SPECIFIED ORIENTATION AND EXPOSURE (TO BE PROVIDED BY PROJECT MEP PRIOR TO CONSTRUCTION).
- 13. RUN UNDERGROUND ELECTRICAL CONDUIT TO PV FRAMES AND INSTALL PANEL WIRING. (LOCATION TO BE PROVIDED BY PROJECT MEP PRIOR TO CONSTRUCTION)
- 14. INSTALL PV COMBINER BOXES WITH FLEXIBLE CONNECTIONS TO CONNECT PV PANELS TO CONDUIT. (LOCATION TO BE PROVIDED BY PROJECT MEP PRIOR TO
- 15. CONSTRUCT CONCRETE EQUIPMENT PADS. INSTALL AND CONNECT GROUND MOUNTED ELECTRICAL EQUIPMENT. A DISCONNECT LOCATION WILL BE ON THE OUTSIDE ON THE NARROWEST SIDE OF THE PLATFORM.
- 16. RUN CONDUIT FROM THE CONCRETE EQUIPMENT PADS TOWARDS THE POINT OF INTERCONNECTION AS DEPICTED ON THE SITE PLAN.
- 17. INSTALL RISER POLES AND UTILITY POLES WITH ELECTRICAL COMPONENTS AND OVERHEAD WIRING FROM THE POINT OF INTERCONNECTION TO THE ARRAY.
- 18. CONSTRUCT ALL 7' HIGH CHAIN LINK FENCE AND GATES. (SHOWN ON PLAN)
- 19. ALL DISTURBED AREAS SHALL BE RE-ESTABLISHED WITH "NEW ENGLAND CONSERVATION/WILDLIFE MIX" (DEPICTED HEREIN). IN THE EVENT THAT THE SEEDING FALLS OUTSIDE OF THE RECOMMENDED SEEDING DATES, DISTURBED AREAS SHALL BE RE-ESTABLISHED USING ALTERNATIVES METHODS AS APPROVED BY THE PROJECT SITE ENGINEER.
- 20. REMOVE ANY ACCUMULATED SEDIMENT FROM THE SEDIMENTATION BASINS. THE SEDIMENTATION BASINS ARE TO BE LINED WITH RIPRAP AND REMAIN IN PLACE AFTER CONSTRUCTION.
- 21. RE-PAVE THE BITUMINOUS CONCRETE AT THEN ENTRANCE TO THE SITE. (SHOWN ON PLANS)
- 22. UPON COMPLETION OF CONSTRUCTION ACTIVITIES WITHIN THE LIMIT OF WORK, THE CONTRACTOR SHALL EFFECTIVELY AND PERMANENTLY STABILIZE THE SITE.

# 44 ESTABROOK AVENUE

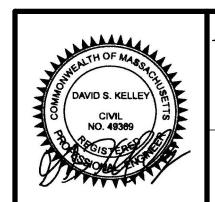

EROSION AND SEDIMENT CONTROL DETAILS LOCATED IN GRAFTON, MASSACHUSETTS

# (WORCESTER COUNTY) PREPARED FOR

BLUEWAVE CAPITAL, LLC DATE: JUNE 12, 2018 SCALE: AS NOTED




BEVERLY, MASSACHUSETTS 01915 WESTBOROUGH, MASSACHUSETTS 01581 TELEPHONE: (978) 299-0447

SHEET No. 13 OF 14

TELEPHONE: (508) 871-7030

PROJECT No. 6108

DWG FILE: 6108_DET.dwg 3:41pm PLOTTED: Jul 27, 2018 dkelley

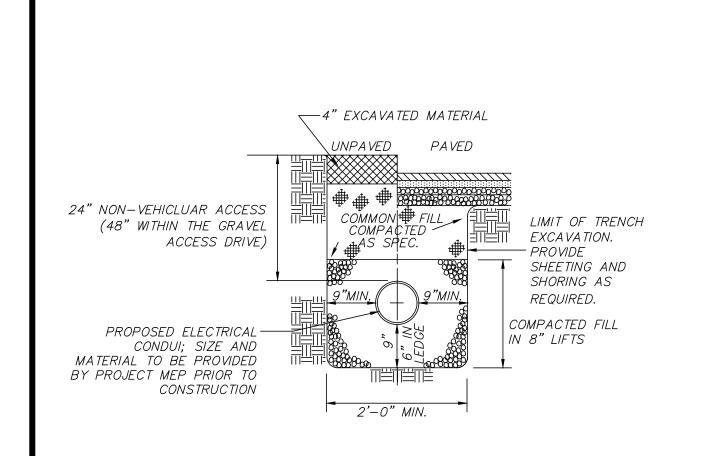

### FILL SPECIFICATION

No. 100

No. 200 (FINES)


FINE AGGREGATE SHALL CONSIST OF HARD, DURABLE SAND, FRE OF CLAY, ORGANIC MATTER, SURFACE COATINGS, AND OTHER DELETERIOUS MATERIALS. SOIL FINER THAN THE No. 200 SIEVE (THE FINES) SHALL BE NONPLASTIC. FINE AGGREGATÈ FILL SHALL CONFORM TO THE REQUIREMENTS OF THE 1988 MASS. HIGHWAY DEPT. STANDARD SPECIFICATIONS FOR HIGHWAYS AND BRIDGES, SECTION M4.02.02A (2010 SUPPLEMENTAL SPECIFICATIONS), FINE AGGREGATE SHALL MEET THE FOLLOWING GRADATION REQUIREMENTS:


SIEVE SIZE PERCENT PASSING BY WEIGHT 3/8 INCH 100 95 - 100 45 - 80 10 - 30 No. 50

2 - 10

FINE AGGREGATE FILL SHALL BE COMPACTED IN MAXIMUM 9-INCH-THICK LOOSE LIFTS TO AT LEAST 95 PERCENT OF THE MAXIMUM DRY DENSITY DETERMINED IN ACCORDANCE WITH ASTM D1557 (MODIFIED AASHTO COMPACTION)

### TYPICAL CONDUIT TRENCH DETAIL (NOT TO SCALE)

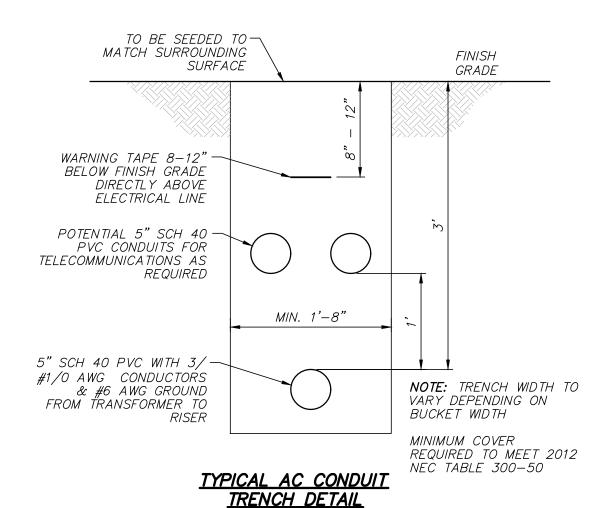


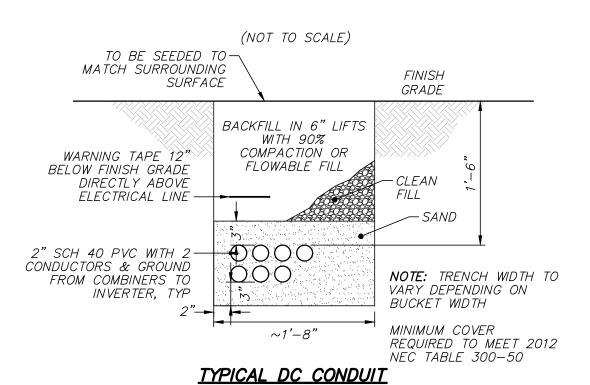

<u>TRENCH DETAIL</u>

(NOT TO SCALE)

(NOT TO SCALE)

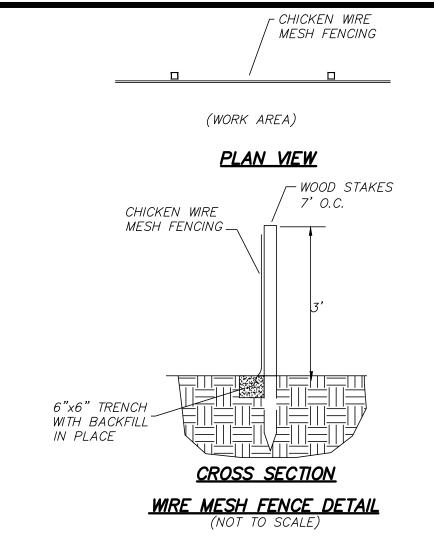

MODULE POTTED

SIDE

TYPICAL PV MODULE. OR APPROVED EQUAL

(NOT TO SCALE)

FRONT

BLOCK (TYP)

*39.0"* 

BACK

JUNCTION BOX -

INSTALLING HOLES -

GROUNDING HOLES -

GROUNDING HOLES-


(TYP OF 4)

DRAIN HOLES -


(TYP OF 8)

(TYP OF 4)


(TYP OF 4)

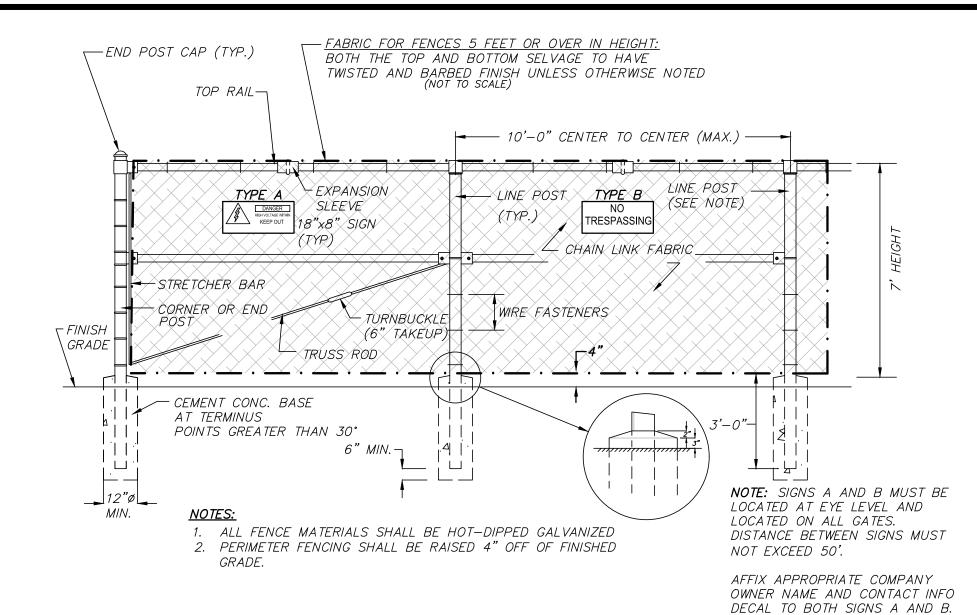

TYPICAL CHAIN LINK FENCE W/ TOPRAIL DETAIL OR APPROVED EQUAL (NOT TO SCALE)

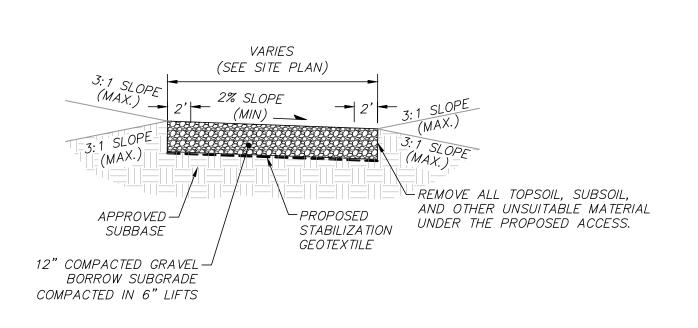

TYPICAL GRAVEL ACCESS DRIVE CROSS SECTION

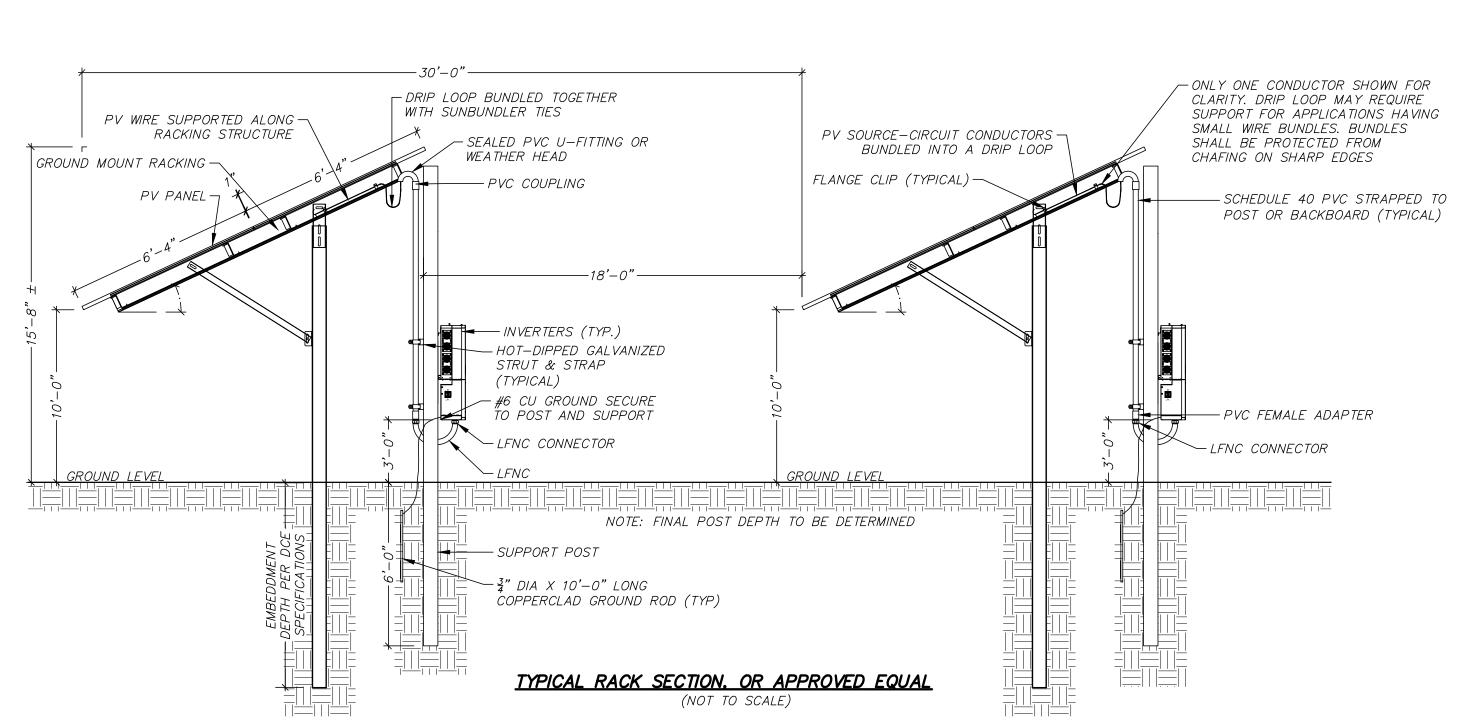

PLANTING MAINTENANCE NOTES: LANDSCAPING SHALL BE PROPERLY MAINTAINED, ANY DEAD OR DISEASED PLANTINGS SHALL BE REPLACED IN THE NEXT IMMEDIATE SPRING OR FALL PLANTING SEASON.


**REVISIONS** 1 |08/03/18| DSK DSK


BY CHK'E


PEER REVIEW COMMENTS


DESCRIPTION

DWG. No. 6108_DET NO. DATE

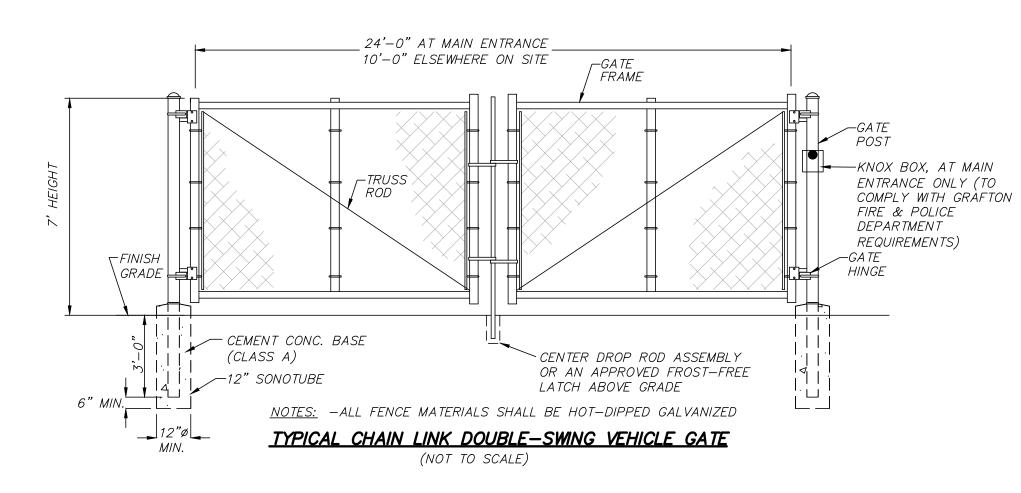


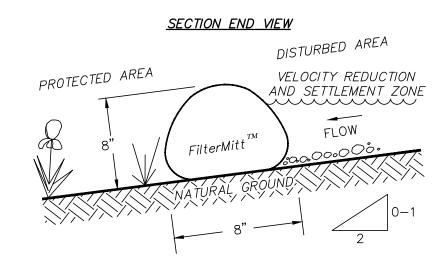

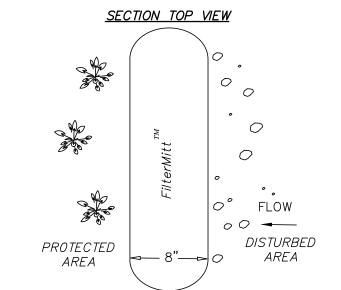

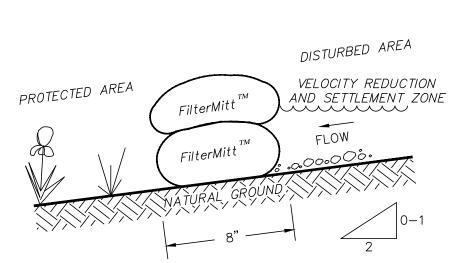

UNION END VIEW

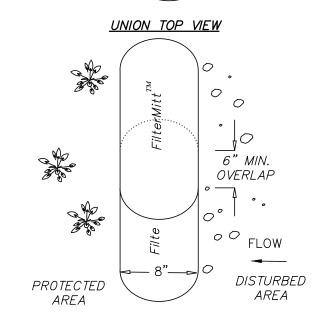

# FilterMitt TM COMPONENTS:

100% organic hessian. OUTSIDE CASING:

FiberRoot Mulch TM FILLER INGREDIENT: • A BLEND OF COARSE AND FINE COMPOST AND SHREDDED • PARTICLE SIZES: 100% PASSING A 3" SCREEN; 90-100% PASSING A 1" SCREEN; 70-100% PASSING A 0.75"

SCREEN; 30-75% PASSING A 0.25" SCREEN. • WEIGHT: APPROX. 310 LBS./CU.YD. (AVE. 11.5 LBS./L.F.)

> For more information visit: <u>www.groundscapesexpress.com</u>or

contact us at: Groundscapes Express, Inc.

P.O. Box 737 Wrentham, MA 02093 (508) 384-7140

# FilterMitt *** INSTALLATION:

WITH THE NEWEST TECHNOLOGY AND EQUIPMENT, SECTIONS CAN BE CONSTRUCTED ON SITE IN LENGTHS FROM 1' TO 100'.

SECTIONS CAN ALSO BE DELIVERED TO THE SITE IN LENGTHS FROM 1' TO 8'.


THE FLEXIBILITY OF FilterMitt™ ALLOWS IT TO CONFORM TO ANY CONTOUR OR TERRAIN WHILE HOLDING A SLIGHTLY ROUND SHAPE AT 8" HIGH BY 8" WIDE.

WHERE SECTION ENDS MEET, THERE SHALL BE AN OVERLAP OF 6" OR GREATER.

# FILTERMITT 2:1 SLOPES OR LESS

(NOT TO SCALE)

# 44 ESTABROOK AVENUE

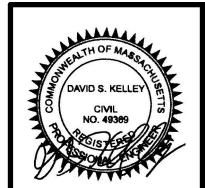

SITE DETAILS LOCATED IN GRAFTON, MASSACHUSETTS

(WORCESTER COUNTY)

PREPARED FOR BLUEWAVE CAPITAL, LLC

DATE: JUNE 12, 2018 SCALE: AS NOTED



SHEET No. 14 OF 14

BEVERLY, MASSACHUSETTS 01915 WESTBOROUGH, MASSACHUSETTS 01581 TELEPHONE: (978) 299-0447 WWW.MERIDIANASSOC.COM

TELEPHONE: (508) 871-7030 PROJECT No. 6108